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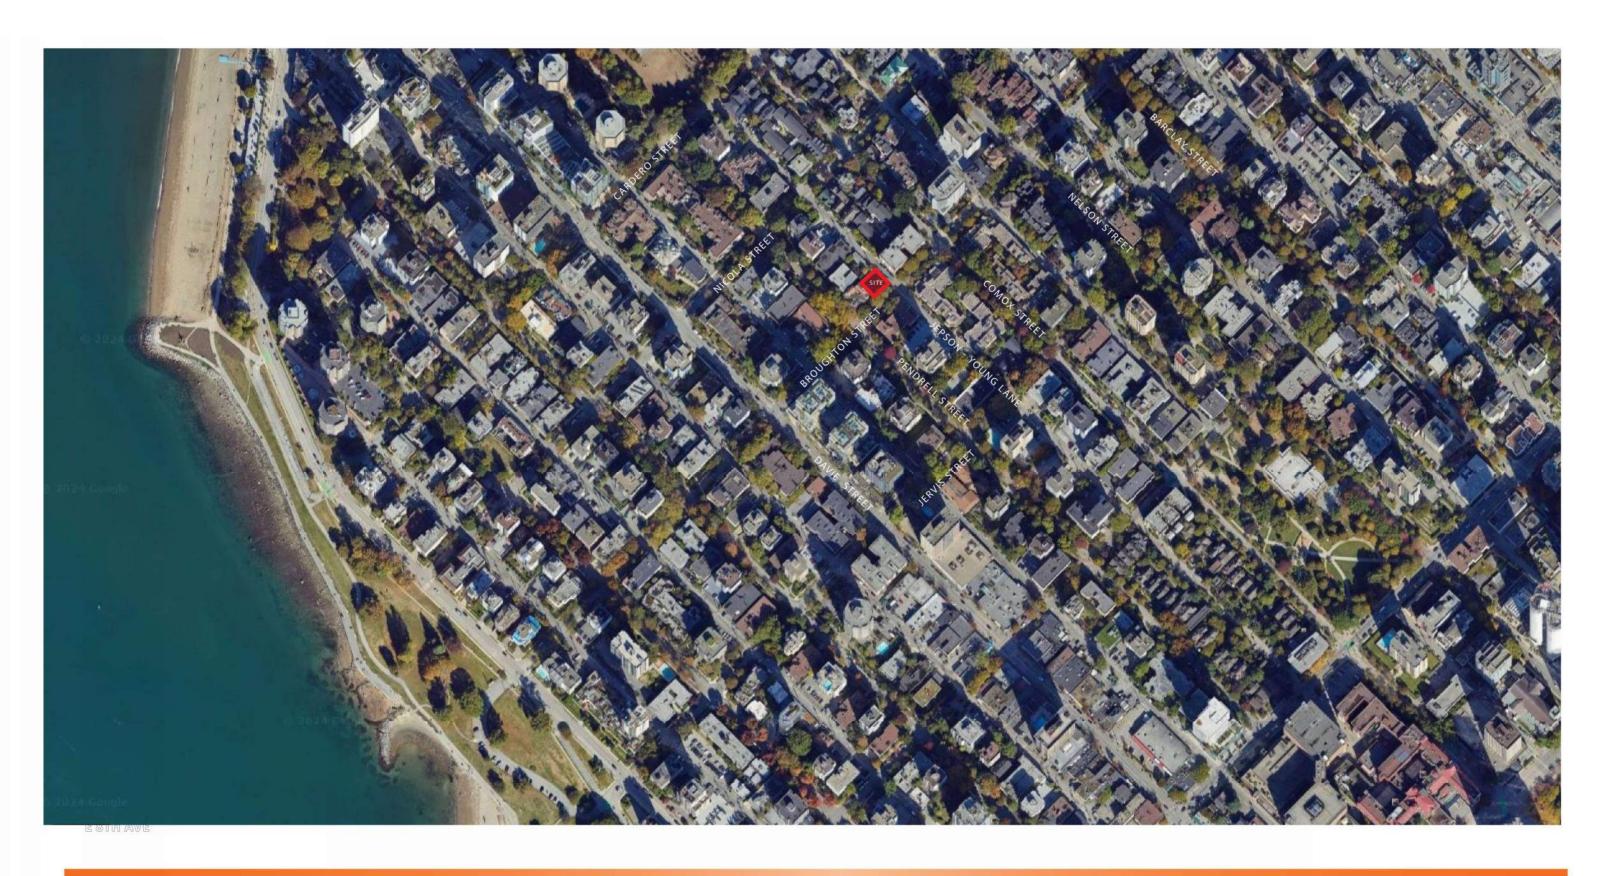


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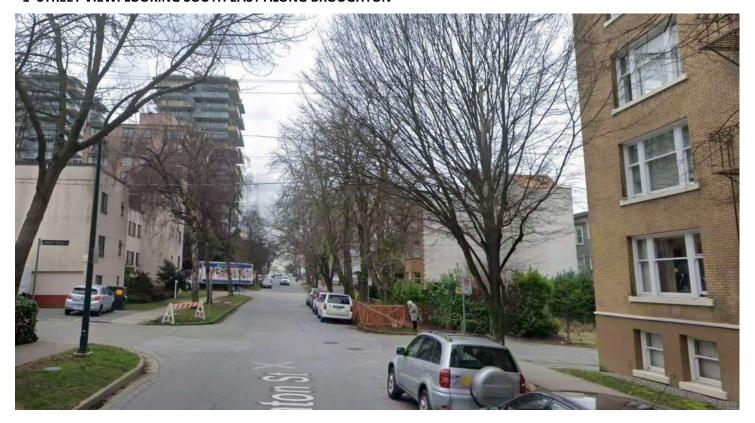








1- STREET VIEW: LOOKING SOUTH EAST ALONG BROUGHTON







3- STREET VIEW: LOOKING SOUTH EAST FROM LANE




















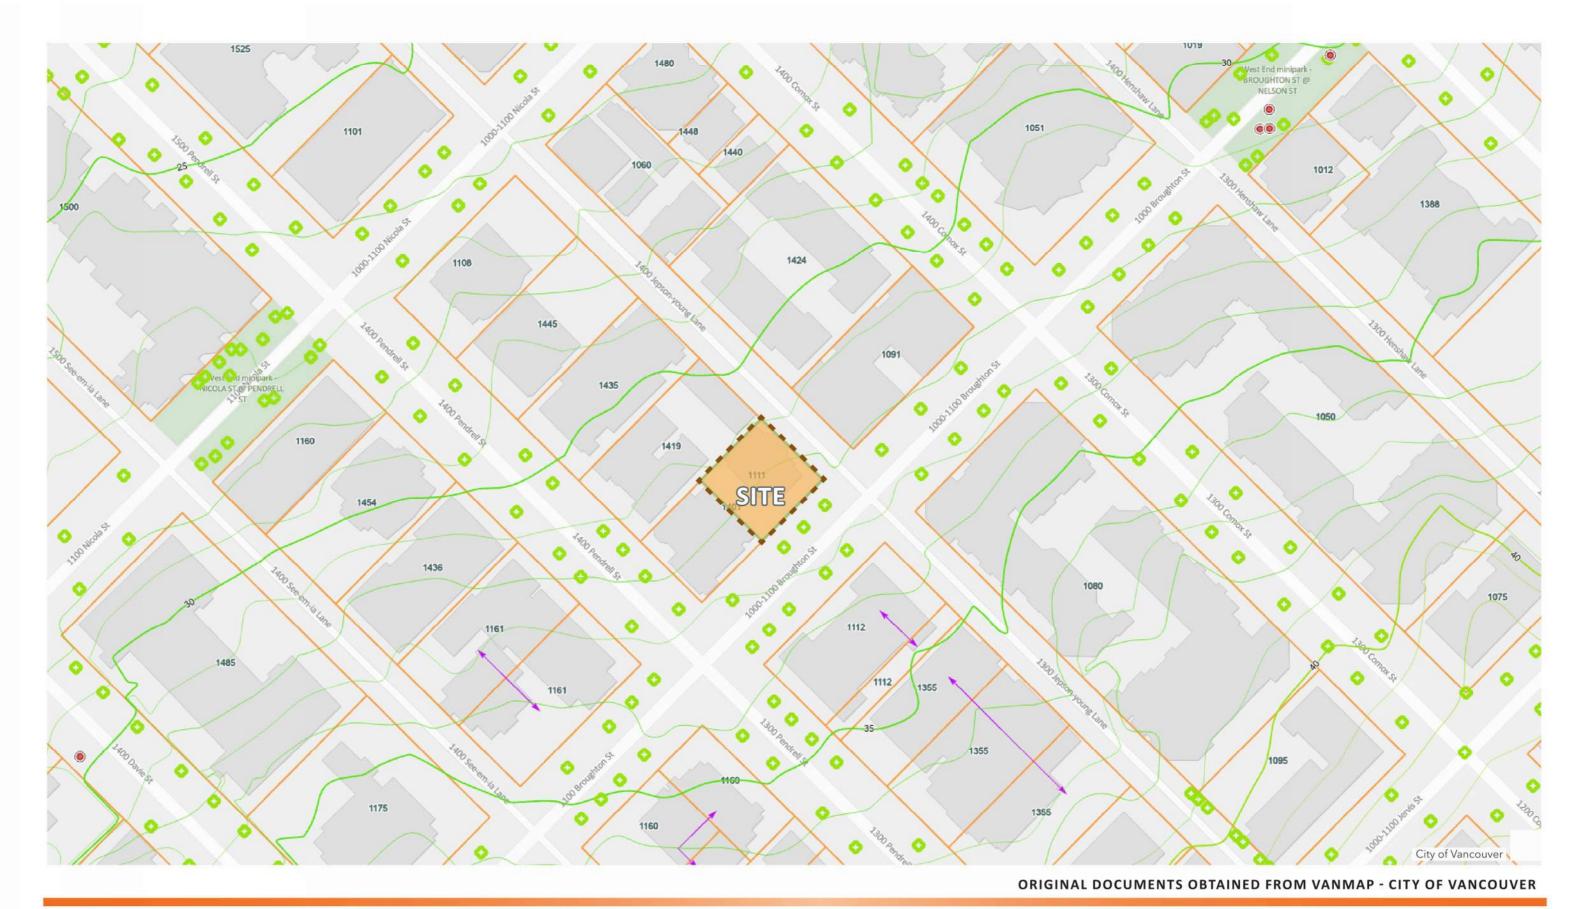







The Bloom Nichloson Group is pleased to submit for consideration this rezoning application for the development site at 1111 Broughton street.

Background

The subject site, 1111 Broughton street, is located on the corner with Jepson Young Lane, in the vibrant and dynamic West end neighbourhood. The neighbourhood is internationally known for its beauty, as the downtown peninsula meets the burrard inlet with a series of beaches and coastal seawall.

The West End is studied by urbanists for its sucessful combination of global city destination with dense residenital living. The result is a friendly, multi demographic residential home for many, which also sucessfully accompdates heritage buildings, parks, amenities and schools.

The site is very well served by public transit and has an array of nearby community amenities.

The subject site is currently vacant and the proposed development is being developed to provide much needed social housing in this sought after location.

Project Goals

The key aims of this project are to:

- Provide additional secured, below-market housing to residents of Vancouver in a period of crisis.
- Create opportunities for a social community to grow.
- Design indoor and outdoor spaces that are robust, beautiful, and connected to their context.
- Achieve a sustainable building with a lighter carbon footprint.

Proposed Development

Finding rental housing in Vancouver that is affordable, suitable and adequate can be a challenge for residents of all income brackets.

The proposed development is uniquely suited to meet the City's Housing objectives while offering an opportunity to transform a centrally located vacant site to better serve residents of Vancouver.

The subject site is proposed to be redeveloped into a 27-storey residential development which will be comprised of both below market rental and rental housing.

RM-5 districts Schedule (2023)

The project site is located within an RM-5 District, the intent of which is to support multiple dwelling forms, while ahieving a number of community and social objectives.

The owner of this site is seeking rezoning approval to permit an intensification of the allowable height and density of the site, to support the delivery of critical housing stock in the neighbourhood, and align with the objectives of the West End Plan and Rezoning Polciy.

West End Rezoning Policy(2023)

The Policy states "Rezoning applications will be considered for increases in density in cases where 100% of the residential is social housing". in Area A.

The subject site is located in an Existing Residential Residential Area, which offer a range of affordable housing options including a significant amount of the City's purpose-built rental housing stock. The Westend Plan envisions increasing housing affordability, and providing choice for existing renters to remain in their neighbourhoods intergenerationally, with requirements for below-market rental units and strengthened tenant protections.

The proposed development will expand existing below-market housing stock, while maintaining affordability, while maintaining the green and leafy character of the street.

Built Form and Site Design Policies

Views

As is envisioned in the revised viewcones 2024, the site will comfortably accommodate the proposed height without encroaching on the applicable viewcones.

Site Frontage and Towers

The proposed development has a site frontage of 19.96 m (65.5 ft), the Tower has been placed to provide an 8ft separation from the adjacent site to the North West, on the Lane on the East.

The tower separation coupled with strategic unit orientation suppports enhanced privacy, while providing natural light and ventilation.

Map 1: West End Rezoning Policy Areas



Interface with the Public Realm/Residential Street

The site is located on a tree-lined residential street, tucked away from the nearby Davie Street, a busy commercial and transit corridor, well known for being bustling with pedestrian activity.

To minimize interruptions to the pedestrian-oriented environment along Broughton Street, access to the loading, garbage and passenger drop off, including access for site servicing and loading vehicles will be limited to Jepson Young lane. A separate and independent access to the main elevators will be provided for Bicycle Storage, via Broughton St. sidewalk.

The building's primary entrances will be provided off Broughton Street and used to establish a strong and desirable residential identity. A community Amenity space occupies the corner and will add another dimension of activity and occupation along the street.

The existing mature trees coupled with landscaping at grade will be used to offer a sense of welcoming to residents accessing the ground floor lobby spaces.

Parking and Loading

A Class B loading space will be provided at grade, open to the lane and one Passenger drop off stall adjacent. The reduced carbon emissions through not proivding a below grade carparking is significant, and ample bicycle parking is provided to meet the zoning requirements, with elevator access from the main core.







Architectural design rationale

The architectural form and expression of this building aims to respond to this diverse context of the West End, through celebrating a verticality, which places imporance and signifiance on the rental housing stock of the neighbourhood. The pencil like form of the 3,493sf floorplate, 27 storey highrise, provides a vertical proportionality which is truely unique, and will provide a visual variation in an area with typically much larger and bulkier floorplate massing.

The vertical striation of solid and glazing throughout the building enhances this massing verticality, and the absense of projection breaking these clean lines allows a true expression of a building streching for a previously unachieveable goal. Infill development at this density happens in a few select locations in the world, This unique project can suceed here, where livibility and demand to be situated within a few square kilometers of Stanley Park, the West End beaches and Downtown, make this project feasible.

The building's architecture also echos the unique character of West End, integrating elements that resonate with the area's historic towers from the 1960's. These including Parapet treatments of vertical stripes breaking the horizontal and a refined material palette with dark and light contrast to achieve an overall aestheic which is refined and timeless. The roof level amenity space with ample outdoor space, is commonplace in these historic buildings also.

The exterior lighting will be designed to mitigate potential issues such as light pollution, light spill or glare, to contribute to the health and well-being of residents and neighbours. The proposed development will embrace a unified architectural concept, while offering variation from neighboring buildings to avoid repetition and to create a visually interesting streetscape environment.

At the street level, there is a deliberate emphasis on creating a clear and inviting expression, with distinct detailing at the base and entry points. This establishes a strong visual connection with the immediate surroundings and contributes to the overall coherence of the neighborhood fabric. As the building ascends, a secondary expression unfolds at the higher levels, when a cantolever is introduced a tthe Lane.

This change in mass creates interest and variety to ensures that the architectural language remains dynamic and engaging, addressing both the pedestrian experience at ground level and the visual impact from a distance.

Clear and recognizable entrances from Broughton Street, serve as a visual anchors, guiding residents and community amenity guests alike to their respective entrances. This will be achieved through the use of distinct signage, well-designed canopies, landscaping elements, and other architectural features that enhance the prominence of each of the entrances.

Setbacks

Given the limited site, reduced setbacks have been proposed on all sides of proposed development, despite this the tower can sensitively transition from adjacent buildings, enhance the existing street and lane frontage through added activation, while visually connecting to the neighbouring taller buildings on adjacent Comox and Davie streets.

Balconies are limited to the west elevation, where a larger setback allows, the increased outdoor amenity rooftop space is provided to ensure residents have ample outdoor space for socialising and receration without leaving the building.

All units have large operable windows for access to fresh air and a connection to outside.



Property Information

Address Information

Civic Number: 1111
Street Name: BROUGHTON ST

Address Status: Active Address Type: Main

Property Report

Local Area: West End

Multi-family Collection Zone: Blue North

Sanitation: Blue North

Nearest Community Centre: West End

Nearest Community Centre Address: 870 Denman St

Nearest Fire Hall: 6

Nearest Fire Hall Address: 1001 Nicola St

Responding Fire Hall: 6

Responding Fire Hall Address: 1001 Nicola St

Zoning Information

Zoning: RM-5 CD1 Number:

Zoning District: RM-5

Zoning Classification: Residential

Legal Information

Full Address: 1111 BROUGHTON ST

PID: 015758966 Primary Lot: 20 Block: 48

Plan Number: VAP92 District Lot: 185

Legal Type: LAND Folio Number: 116607550000

Legal Description:

LOT 20 BLOCK 48 PLAN VAP92 DISTRICT LOT 185 NWD

PART N 1/2.

Postal Code: V6G 2A9 Record Status: Neighbourhood: 027








SUSTAINABILITY MEASURES

Sustainability

We are committed to developing a project that meets high standards of sustainability. The project has and will continue to consider all aspects of energy use to create an energy efficient design that optimizes a mix of passive solar-design strategies, energy efficient equipment, and renewable sources of energy.

All existing mature street trees will be retained, as they will support a healthy urban forest canopy, reduce urban heat island effects, and contribute to the leafy, tree-lined feel of the neighbourhood.

Appropriate treatment and safe conveyance of rainwater are considered in the site design and all related measures will be aligned with the City-Wide Integrated Rainwater Management Plan (IRMP) requirements.

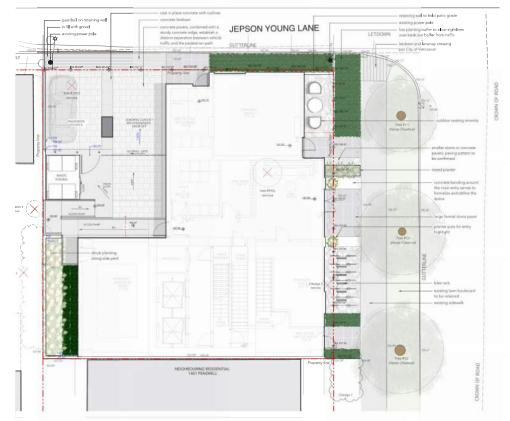

Energy and Emissions Performance

The Building has been modeled for compliance with the energy targets outlined in the Vancouver Green Building Policy for Rezoning 2023 (GBPR) and Vancouver Building Bylaw 2019 (VBBL), Part 10, Article 10.2.2.5. Building Energy and Emmisions Performance. Further the Social Housing portion is required to achieve the energy and emissions targets from BC Housing Design Guidelines and Construction Standards (BCH-DGCS).

Market Housing will be equipped with a Low Carbon Energy System (LCES) in accordance with Vancouver LCES Policy (LCES Type 3: User-owned, Onsite).

To meet the stated Whole Building Performance Limits, the following practices have been incorporated into the design:

- A Window-Wall Ratio of 35%
- High performance glazing
- Overall Effective R value for the Roof, and Exterior Walls at 18.1 and 6.5, respectively.
- Heating / Cooling
 Packaged Terminal Air Source Heat Pump System for Living room
 Electric Baseboard Heater for other bedrooms
- Ventilation

Direct Ventilation by High Efficiency Unitized ERV


Embodied Carbon Limits

Preliminary calculations of embodied carbon have been performed based on the building's rezoning concept design. These results have been for consieration in meeting the requirements of the City of Vancouver Green Buildings Policy for Rezoning (GBPR) and Vancouver Building bylaw 2019 (VBBL), Part 10, Section 10.4. Low Carbon Construction.

The obtained results confirm that the project will meet the expected Embodied Carbon limits from GBPR / VBBL by the time of first building permit application as planned at this early stage.

Resilient Buildings Planning Worksheet

A preliminary exercise in building resilience has been completed for the project to identify potential risks and hazards that may arise throughout the building's lifespan. An initial Resilient Buildings Planning Worksheet is included as part of this submission.

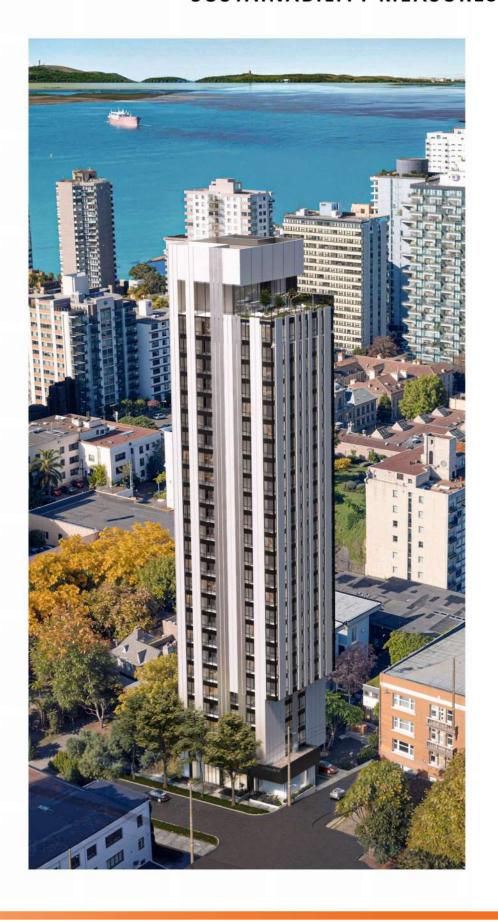











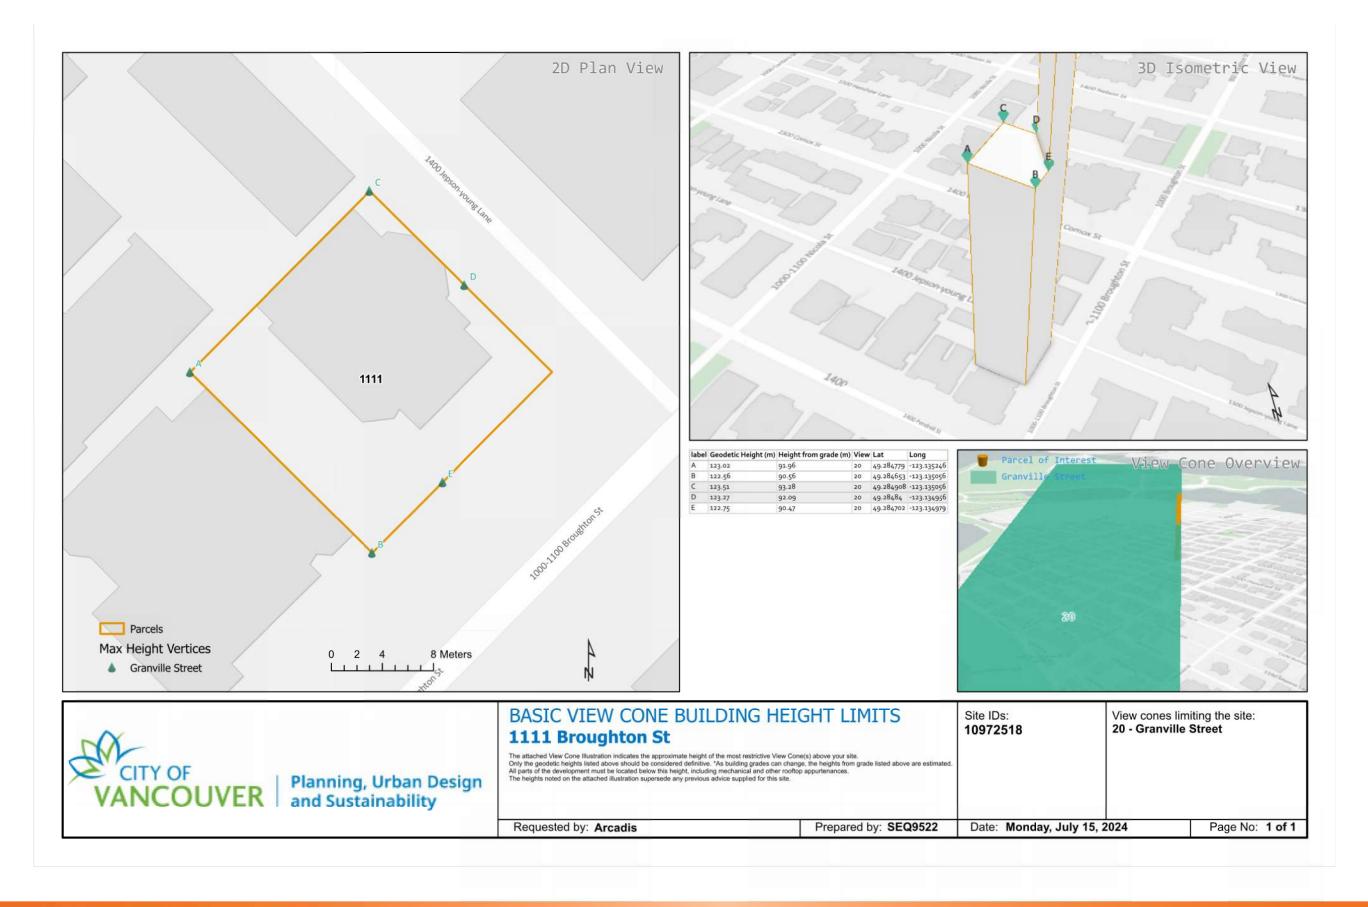








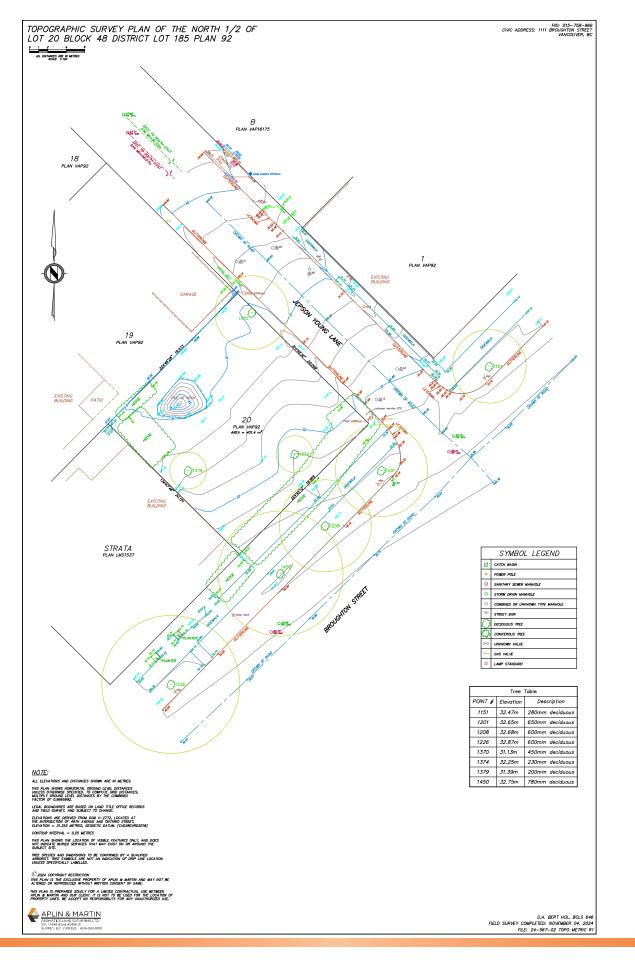







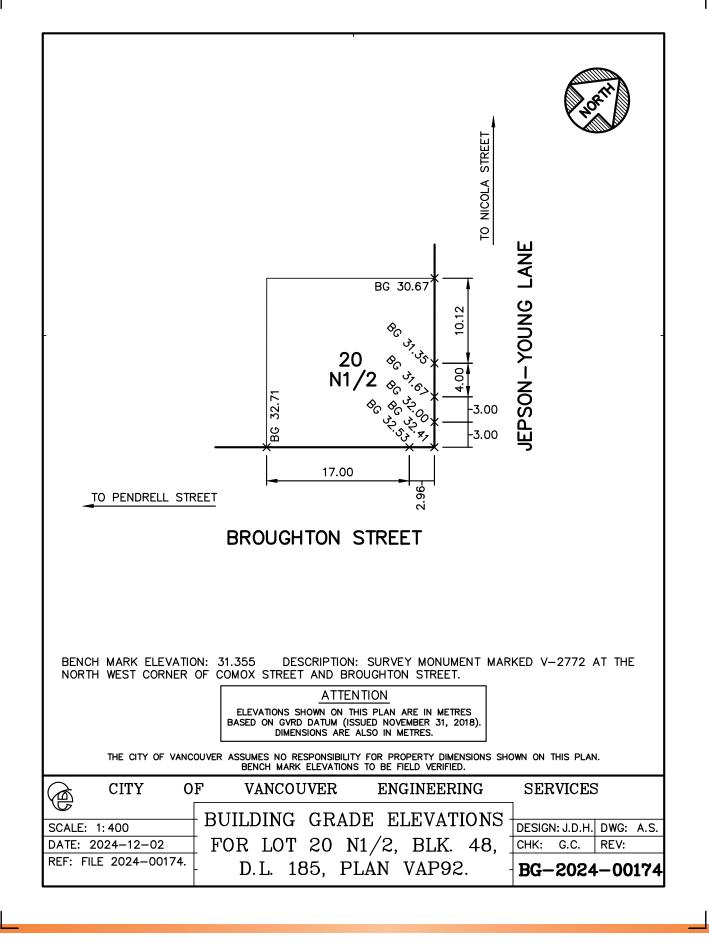







PRINCIPAL LVI		Gross Floor Area		Floor Area		
USE		SQ FT	Storage (25sf / unit)	Amenity / Community	Exclusions Sub-Total	SQ. FT.
Mechanical	Mech	1,635	0	0	0	1,0
Amenity	Roof	2,242	0	2,242	2,242	
	25	3,493	174	0	173	3,
	24	3,493	174	0	173	3,
	23	3,493	174	0	173	3,
	22	3,493	174	0	173	3,
	21	3,493	174	0	173	3,
	20	3,493	174	0	173	3,
	19	3,493	174	0	173	3,
	18	3,493	174	0	173	3,
	17	3,493	174	0	173	3,
	16	3,493	174	0	173	3,
	15	3,493	174	0	173	3,
Residential	14	3,493	174	0	173	3,
	13	3,493	174	0	173	3,
	12	3,493	174	0	173	3,
	11	3,493	174	0	173	3,
	10	3,493	174	0	173	3,
	9	3,493	174	0	173	3,
	8	3,493	174	0	173	3,
	7	3,493	174	0	173	3,
	6	3,493	174 102	0	173	3,
	5	2,926 2,926	102	0	102 102	2, 2,
	3	2,926	102	0	102	2,
	2	3,101	102	0	102	2,
Lobby	1	2,755	0	402	402	2,
		,	<u>'</u>			,
ΓAL (SF.)		88,371	3,888	2,644	6,512	81,859

Level	Studio (<65sm)	Studio Accessible (<65sm)	1Br (<65sm)	2Br (<65sm)	Total
Roof					
25	4	0	2	0	6
24	4	0	2	0	6
23	4	0	2	0	6
22	4	0	2	0	6
21	4	0	2	0	6
20	4	0	2	0	6
19	4	0	2	0	6
18	4	0	2	0	6
17	4	0	2	0	6
16	4	0	2	0	6
15	4	0	2	0	6
14	4	0	2	0	6
13	4	0	2	0	6
12	4	0	2	0	6
11	4	0	2	0	6
10	4	0	2	0	6
9	4	0	2	0	6
8	4	0	2	0	6
7	4	0	2	0	6
6	4	0	2	0	6
5	0	1	1	2	4
4	0	1	1	2	4
3	0	1	1	2	4
2	0	1	1	2	4
1	0	0	0	0	0
Unit type	Studio	Studio Accessible	1Bed	2 Bed	Total
Total	80	4	44	8	136
% Unit Mix	58.8%	2.9%	32.4%	5.9%	







1111 Broughton Street

Site & Project Description

Project Description:

Residential Social housing with Rental and Amenity

Civic Address:

1111 Broughton Street

City Plan: West End Permitted uses:

Current Zoning: RM-5 CD-1 Multifamily Residential & Rental Housing

 Current Use:
 Vacant

 Adjacent Zoning:
 RM-5 & CD-1

 Rezoned to:
 CD-1

Transit: Bus Lines on Davie, West Georgia, Robson, 500m

SITE AREA CALCULATIONS

Gross Site Area

Metric (m²⁾ Imperial (sq.ft.)

1111 Broughton Street 402 4323

FLOOR AREA (FAR) CALCULATIONS

Rezoning CD-1	FAR	FAR Area		
Rezoning CD-1		Metric (m²)	Imperial (sq.ft.)	
Proposed Rezoning Permitted FSR Ratio	18.9	7,605	81,859.1	

SITE DIMENSIONS				
	Width (Broughton Frontage)		Depth (Lane Frontage)	
	Metric	Imperial	Metric	Imperial (Ft)
Gross	19.96	65.50	20.09	65.90

BUILDING SETBACKS							
RM-5							
Required Proposed Tower				ver Mass			
	Property Line	Metric	Imperial (Ft)	Metric	Imperial (Ft)		
Broughton Street	Front yard	3.70	12.14	0.61	2.00		
Lane	Side yard	2.10	6.89	0.91	3.00		
Interior side yard Sorth West	Side yard	2.10	6.89	2.44	8.00		
Interior side yard South West	Side yard	2.10	6.89	0.00	0.00		

SITE COVERAGE CALCULATIONS					
	Metric (m2)	Imperial (sq.ft.)			
Gross Site Area	402	17,307.00			
Building Footprint at ground	254	2,733.50			
Site Coverage %		63%			
RM-5 Permitted:		50%			

HEIGHT OF BUILDING (MEASURED FROM LOBBY LEVEL)			
Height Permitted	Metric (m)	Imperial (ft)	
Max height (RM-5)	18.3	6	50

Height Provided	Towe	r
neight Floyided	metric (m)	imperial (ft)
NUMBER OF RESIDENTIAL FLOORS		25
HEIGHT FROM BASE POINT TO TOP OF PARAPET	88.0	288.8
TOP OF PARAPET	119.5	392.0
Base Point	31.5	103.2

Levels	Unit numbers	Total
02 - 04	Unit 02	
05		(
06-07	Unit 03	2
08- 25		(
Total		5

AMENITY SPACES

Provided	Metric (m2)	Imperial (sq.ft.)
Indoor	211	2267
Outdoor	120	1289







PROPOSED STREET VIEW























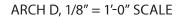

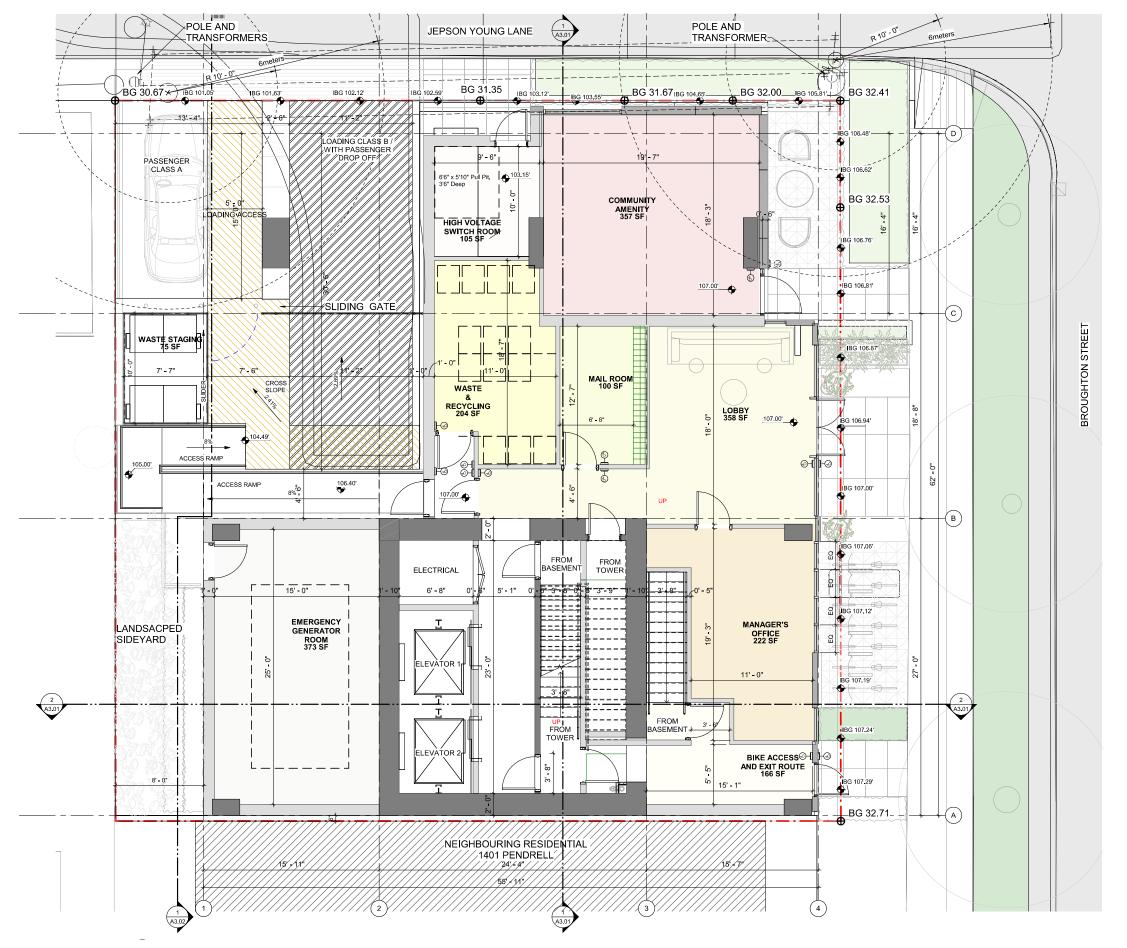

















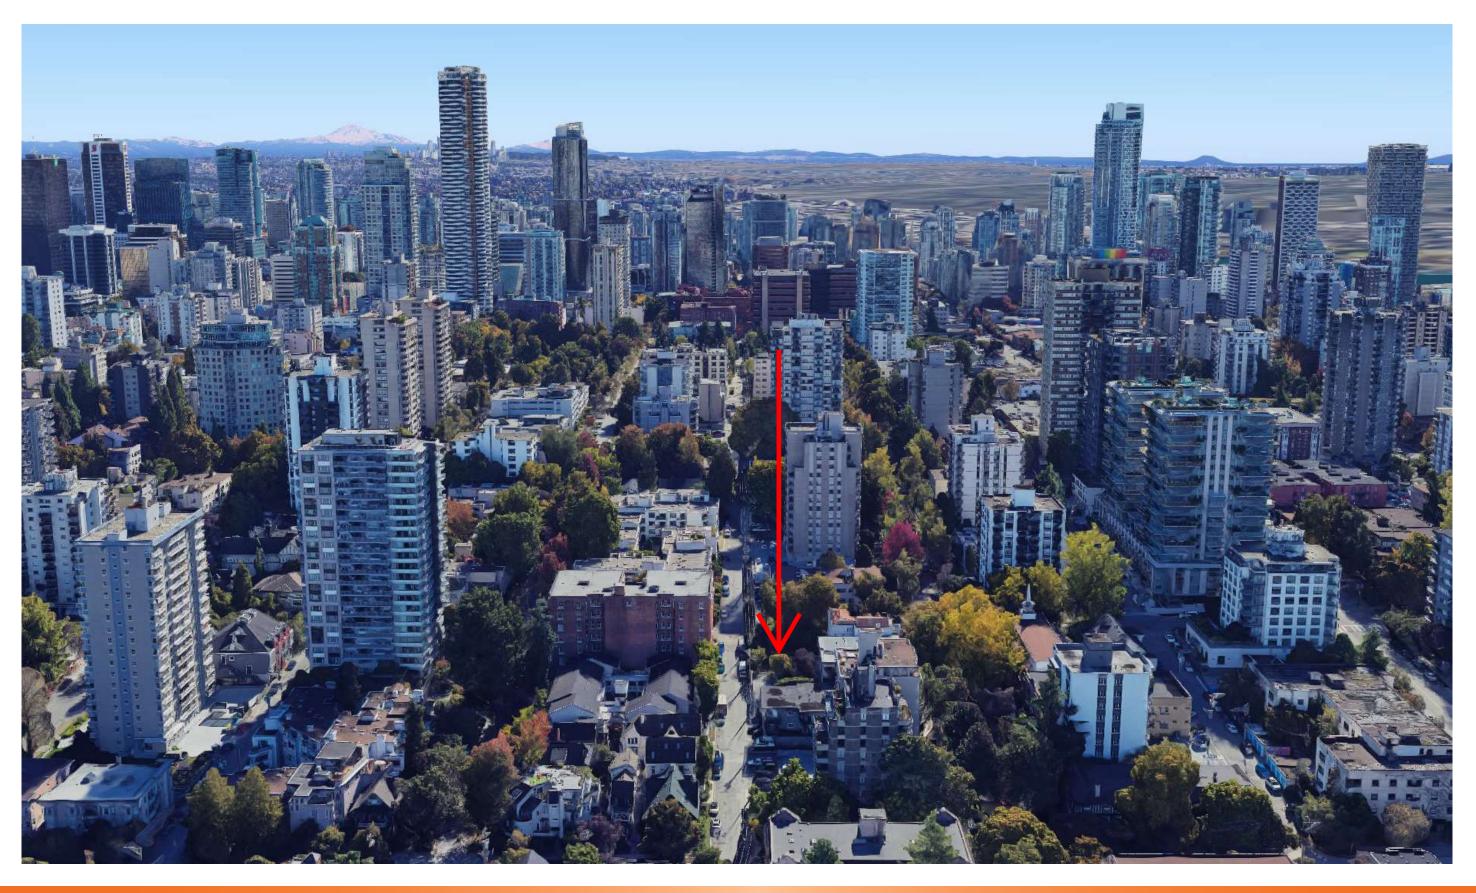








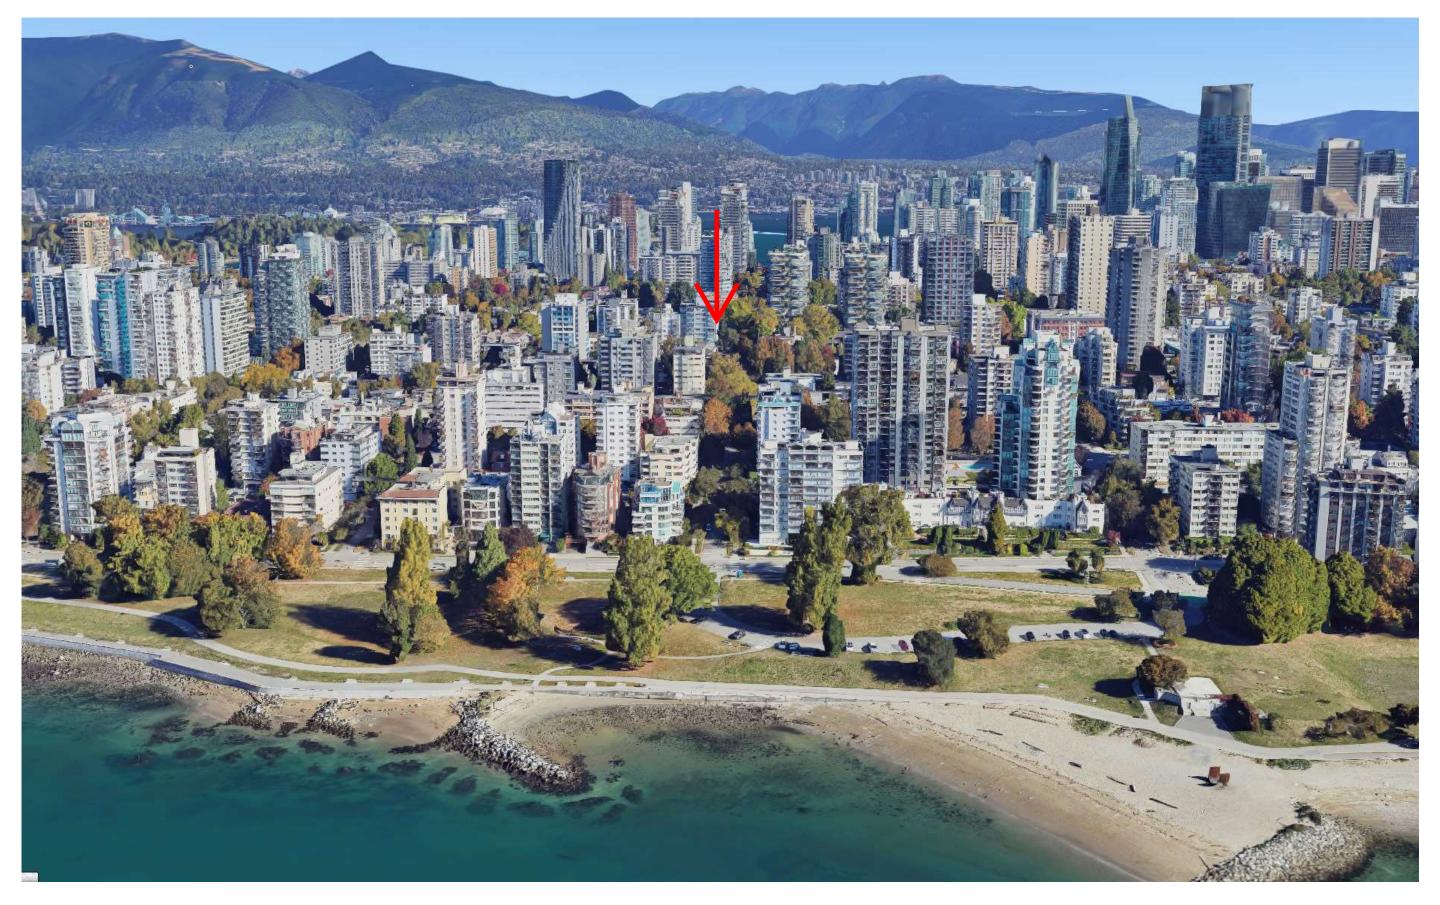







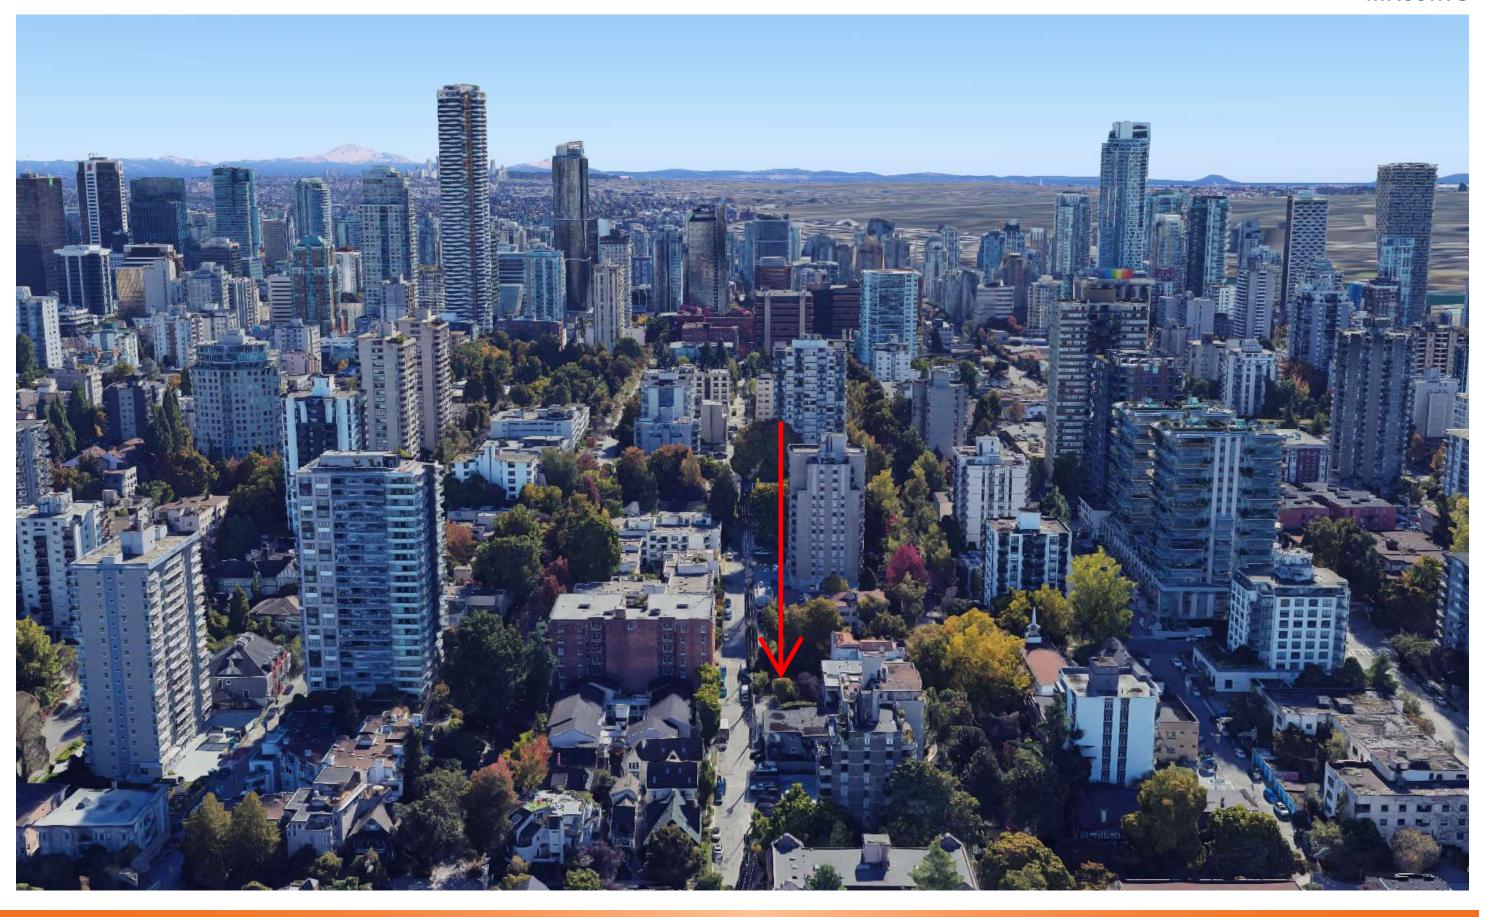










SHADOW STUDY - MARCH/ SEPT



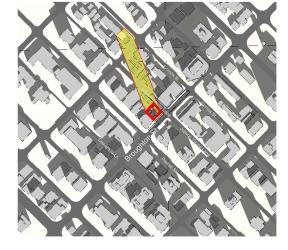

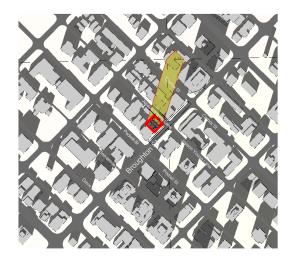

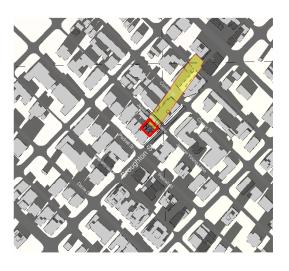


Sep 21 10:00 am


Sep 21 2:00 pm

Sep 21 3:00 pm

SPRING EQUINOX - MARCH 21st

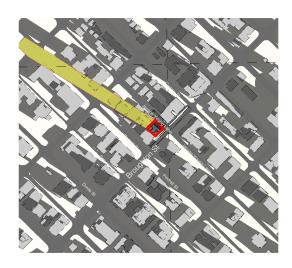



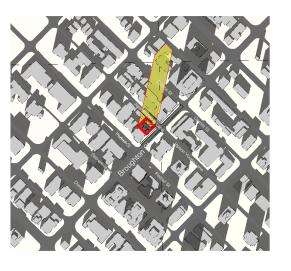



March 21 10:00 am

March 21 12:00 pm

Sep 21 12:00 pm

March 21 2:00 pm

March 21 3:00 pm









APPENDIX A

ARCHITECTURAL DRAWINGS







REZONING SUBMISSION

1111 BROUGHTON STREET, VANCOUVER ARCHITECTURAL DRAWING PACKAGE

	Sheet List - Rezoning
Sheet Number	Sheet Name
A0.01	STATISTICS
A0.02	STATITICS FSR AND UNITS
A0.03	CONTEXT PLAN
A0.04	SITE PLAN
A0.05	CITY BUILDING GRADE
A0.06	BASE POINT CALCULATION
A0.07	SURVEY PLAN
A0.08	SETBACKS PLAN
A0.08A	SITE AND CONTEXT PHOTOS
A0.08B	SITE SURROUNDING CONTEXT
A0.09	BUILDING STREET SCAPE
A0.10	VIEW CONES
A0.11	SHADOW STUDY
A0.12	RENDERINGS
A0.13	RENDERINGS
A0.14	RENDERINGS
A0.15	RENDERINGS
A0.16	RENDERINGS
A0.17	RENDERINGS
A0.18	RENDERINGS
A0.19	DAY LIGHT ANGLE ANALYSIS LEVEL 02-03
A0.20	DAY LIGHT ANGLE ANALYSIS LEVEL 04-05
A0.21	DAY LIGHT ANGLE ANALYSIS LEVEL 06-07
A0.22	DAY LIGHT ANGLE ANALYSIS LEVEL 07-25
A1.01	LEVEL P2
A1.02	LEVEL P1
A1.03	LEVEL 01
A1.04	LEVEL 02 TO 05 FLOOR PLAN
A1.05	LEVEL 06 TO 25 FLOOR PLAN
A1.06	ROOF LEVEL AMENITY
A1.07	UPPER MECH. FLOOR CONCEPT
A1.08	ELEVATOR OVERRUN ROOF
A2.01	EAST AND WEST ELEVATION
A2.02	NORTH AND SOUTH ELEVATION
A3.01	BUILDING SECTIONS
A3.02	ENLARGED SECTIONS, ROOF AND LOADING
A8.01	FSR LEVEL 01
A8.02	FSR LEVEL 02 To 05
A8.03	FSR LEVEL 06 To 14
A8.04	FSR LEVEL 15 To 21
A8.05	FSR LEVEL 24 To 25
A8.06	FSR ROOF LEVEL AMENITY
A8.07	FSR UPPER MECH. FLOOR CONCEPT





1111 Broughton Street

Site & Project Description **Project Description:** Residential Social housing with Rental and Amenity Civic Address: 1111 Broughton Street West End City Plan: Permitted uses:

RM-5 Current Zoning: CD-1 Multifamily Residential & Rental Housing Current Use: Vacant

Adjacent Zoning: RM-5 & CD-1 CD-1

Bus Lines on Davie, West Georgia, Robson, 500m

SITE AREA CALCULATIONS **Gross Site Area** Imperial (sq.ft.)

FLOOR AREA (FAR) CALCULATIONS

1111 Broughton Street

Rezoning CD-1	FAR	FAR Ar	ea
Rezoning CD-1		Metric (m²)	Imperial (sq.ft.)
Proposed Rezoning Permitted FSR Ratio	18.9	7,605	81,859.1

SITE DIMENSIONS				
	Width (Brough	ton Frontage)	Depth (Lane F	rontage)
	Metric	Imperial	Metric	Imperial (Ft)
Gross	19.96	65.50	20.09	65.90

BUILDING SETBACKS					
		RM-5			
	Proporty Line	Requi	red	Proposed Tow	er Mass
	Property Line	Metric	Imperial (Ft)	Metric	Imperial (Ft)
Broughton Street	Front yard	3.70	12.14	0.61	2.00
Lane	Side yard	2.10	6.89	0.91	3.00
Interior side yard Sorth West	Side yard	2.10	6.89	2.44	8.00
Interior side yard South West	Side yard	2.10	6.89	0.00	0.00

SITE COVERAGE CALCULATIONS		
	Metric (m2)	Imperial (sq.ft.)
Gross Site Area	402	17,307.00
Building Footprint at ground	254	2,733.50
Site Coverage %		63%
RM-5 Permitted:		50%

HEIGHT OF BUILDING (MEASURED FROM LOBBY LEVEL)		
Height Permitted	Metric (m)	Imperial (ft)
Max height (RM-5)	18.3	60

Height Provided	Towe	er
Height Frovided	metric (m)	imperial (ft)
NUMBER OF RESIDENTIAL FLOORS		25
HEIGHT FROM BASE POINT TO TOP OF PARAPET	88.0	288.8
TOP OF PARAPET	119.5	392.0
Base Point	31.5	103.2

AMENITY SPACES

Provided	Metric (m2)	Imperial (sq.ft.)
Indoor	211	2267
Outdoor	120	1289

PROPERTY INFORMATION

Address Information

Civic Number: 1111

Street Name: BROUGHTON ST Address Status: Active Address Type: Main

Property Report

Local Area: West End

Multi-family Collection Zone: Blue North

Sanitation: Blue North

Nearest Community Centre: West End

Nearest Community Centre Address: 870 Denman St

Nearest Fire Hall: 6

Nearest Fire Hall Address: 1001 Nicola St

Responding Fire Hall: 6

Responding Fire Hall Address: 1001 Nicola St

Zoning Information

Zoning: RM-5 CD1 Number: Zoning District: <u>RM-5</u> Zoning Classification: Residential

Legal Information

Full Address: 1111 BROUGHTON ST

PID: 015758966 Primary Lot: 20 Block: 48 Plan Number: VAP92 District Lot: 185

Legal Type: LAND

Folio Number: 116607550000

Legal Description:

LOT 20 BLOCK 48 PLAN VAP92 DISTRICT LOT 185 NWD

PART N 1/2. Postal Code: V6G 2A9 Record Status: Neighbourhood: 027

REQUIRED / PROVIDED BICYCLE PARKING

<u>Residential</u>

Class A:

1.5 space for unit under 65 m2 (655sf);

2.5 space for unit 65 m2 (655sf) -105 m2 (1130sf);

3 space for unit over 105 m2

Class B: 2 spaces for any development with at least 20 dwelling units with an additional one space for each 20 additional dwelling units

6.3.21 Electrical outlets: Each two Class A bicycle spaces must have an electrical outlet

Required

Туре	Non-Market Rental
Long Term Bikes (Class A)	204
Short Term Bikes (Class B)	5

Туре	Units (<65sm)	1Br (<65sm)	2Br (<65sm)	2Br (65- 105sm)	3Br (<105sm)	3Br (>105sm)	Total Units
Unit category for Bike Count	136						136
Bylaw bike count Multiplier	x1.5	x1.5		x2.5		x3	Total Bikes
Required Bike count	204.00	-			-	-	204

,								
		Required Long Term Bike	Lockers (Min. 10%)	Stacked(Max. 30%)	Vertical (Max. 30%)	Oversize (Min. 5%)	Horizontal (Min. 25%)	EV Outlets
	Total Required	204	20	61	61	10	51	102
	Total Provided	204	20	Х	Х	Х	51	102

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PROJECT

1111 Broughton St

1111 Broughton Street Vancouver,BC PROJECT NO:

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	DRAWN BY:	CHECKED BY:
	148581	

STATISTICS

A0.01

1111 Broughton Street - Area Tabulations							
20th Dec 2024							
PRINCIPAL USE	LVL	Gross Floor Area SQ FT	Storage (25sf / unit)	Exclusions Amenity / Community	Exclusions Sub-Total	Floor Area SQ. FT.	
Mechanical	Mech	1,635	0	0	0	1,635	
Amenity	Roof	2,242	0	2,242	2,242	0	
	25	3,493	174	0	173	3,320	
	24	3,493	174	0	173	3,320	
	23	3,493	174	0	173	3,320	
	22	3,493	174	0	173	3,320	
	21	3,493	174	0	173	3,320	
	20	3,493	174	0	173	3,320	
	19	3,493	174	0	173	3,320	
	18	3,493	174	0	173	3,320	
	17	3,493	174	0	173	3,320	
	16	3,493	174	0	173	3,320	
	15	3,493	174	0	173	3,320	
Residential	14	3,493	174	0	173	3,320	
Roomania	13	3,493	174	0	173	3,320	
	12	3,493	174	0	173	3,320	
	11	3,493	174	0	173	3,320	
	10	3,493	174	0	173	3,320	
	9	3,493	174	0	173	3,320	
	8	3,493	174	0	173	3,320	
	7	3,493	174	0	173	3,320	
	6	3,493	174	0	173	3,320	
	5	2,926	102	0	102	2,824	
	4	2,926	102	0	102	2,824	
	3	2,926	102	0	102	2,824	
	2	3,101	102	0	102	2,999	
Lobby	1	2,755	0	402	402	2,353	
TOTAL (SF.)	OTAL (SF.) 88,371 3,888 2,644 6,512					81,859	
					_		
						FAR	
		Site Area	4323	SQSF		18.9	

UNIT COUNT						
Level	Studio (<65sm)	Studio Accessible (<65sm)	1Br (<65sm)	2Br (<65sm)	Total	
Roof						
25	4	0	2	0	6	
24	4	0	2	0	6	
23	4	0	2	0	6	
22	4	0	2	0	6	
21	4	0	2	0	6	
20	4	0	2	0	6	
19	4	0	2	0	6	
18	4	0	2	0	6	
17	4	0	2	0	6	
16	4	0	2	0	6	
15	4	0	2	0	6	
14	4	0	2	0	6	
13	4	0	2	0	6	
12	4	0	2	0	6	
11	4	0	2	0	6	
10	4	0	2	0	6	
9	4	0	2	0	6	
8	4	0	2	0	6	
7	4	0	2	0	6	
6	4	0	2	0	6	
5	0	1	1	2	4	
4	0	1	1	2	4	
3	0	1	1	2	4	
2	0	1	1	2	4	
1.	0	0	0	0	0	
Unit type	Studio	Studio Accessible	1Bed	2 Bed	Total	
Total	80	4	44	8	136	
% Unit Mix	58.8%	2.9%	32.4%	5.9%		

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PROJECT NO:
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PROJECT MGR: APPROVED BY:
Designer Approver

ISSUE

Designer Approver

SHEET TITLE

STATITICS FSR AND UNITS


sheet number A0.02

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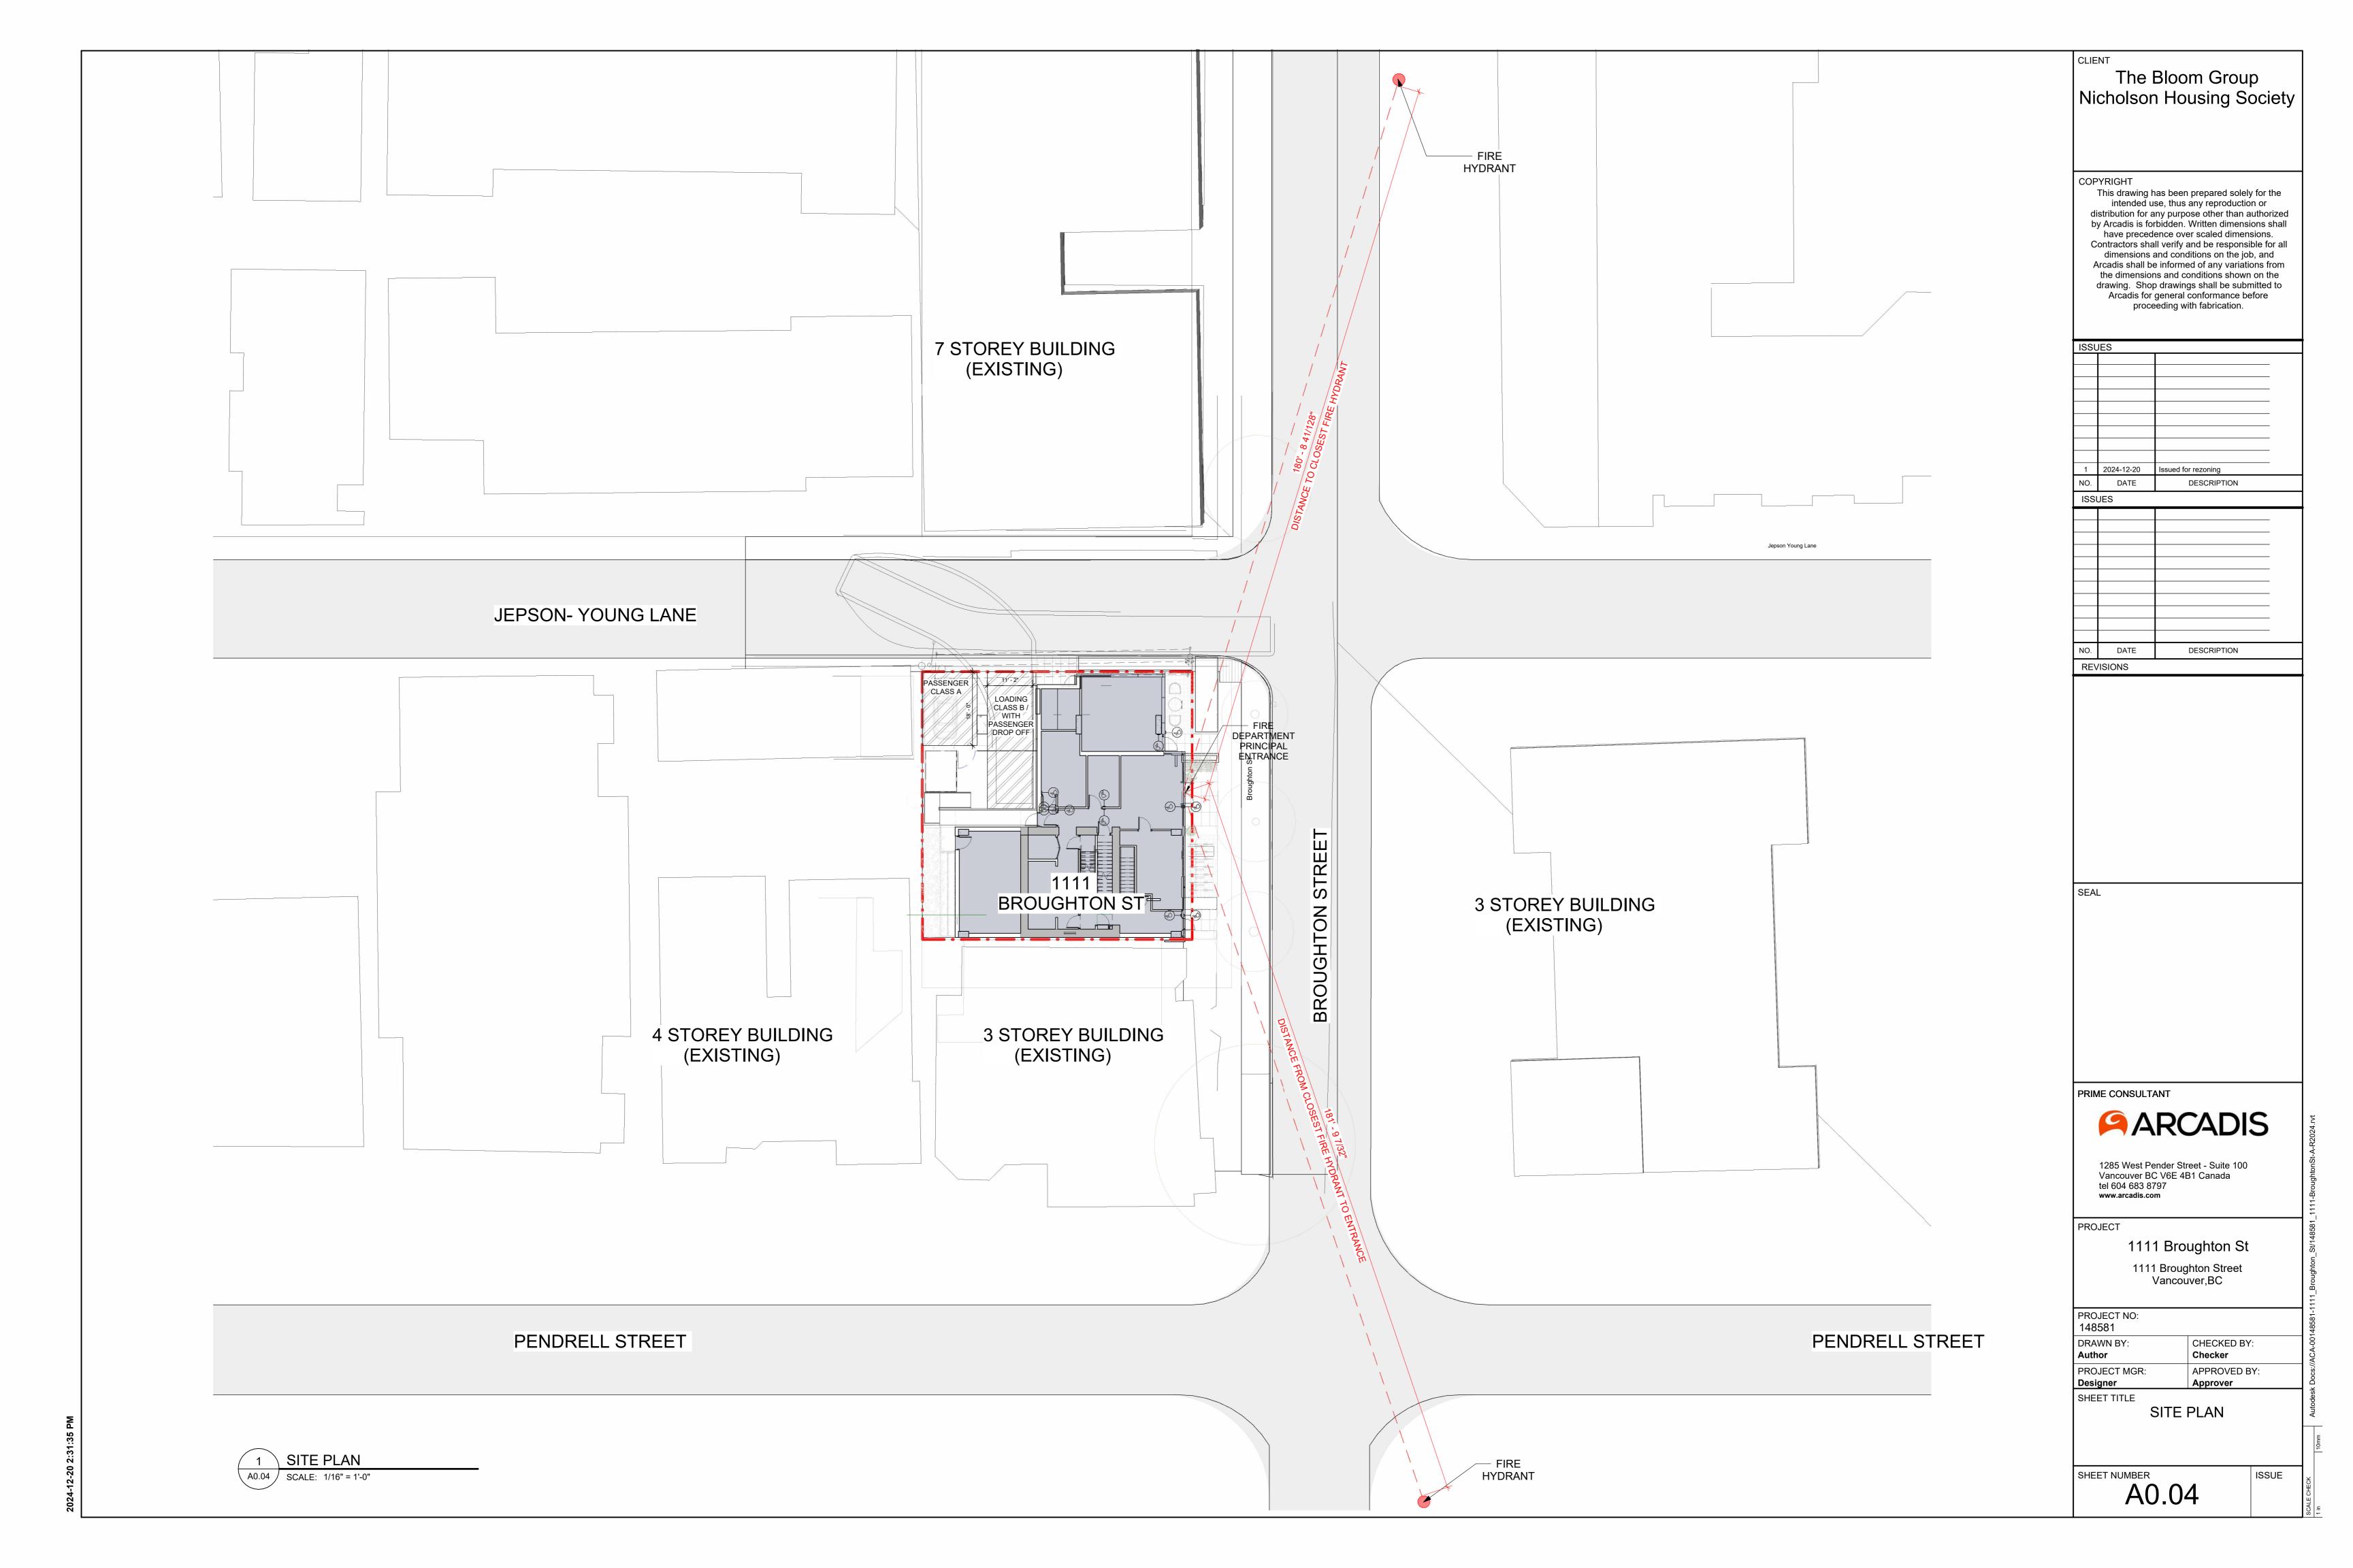
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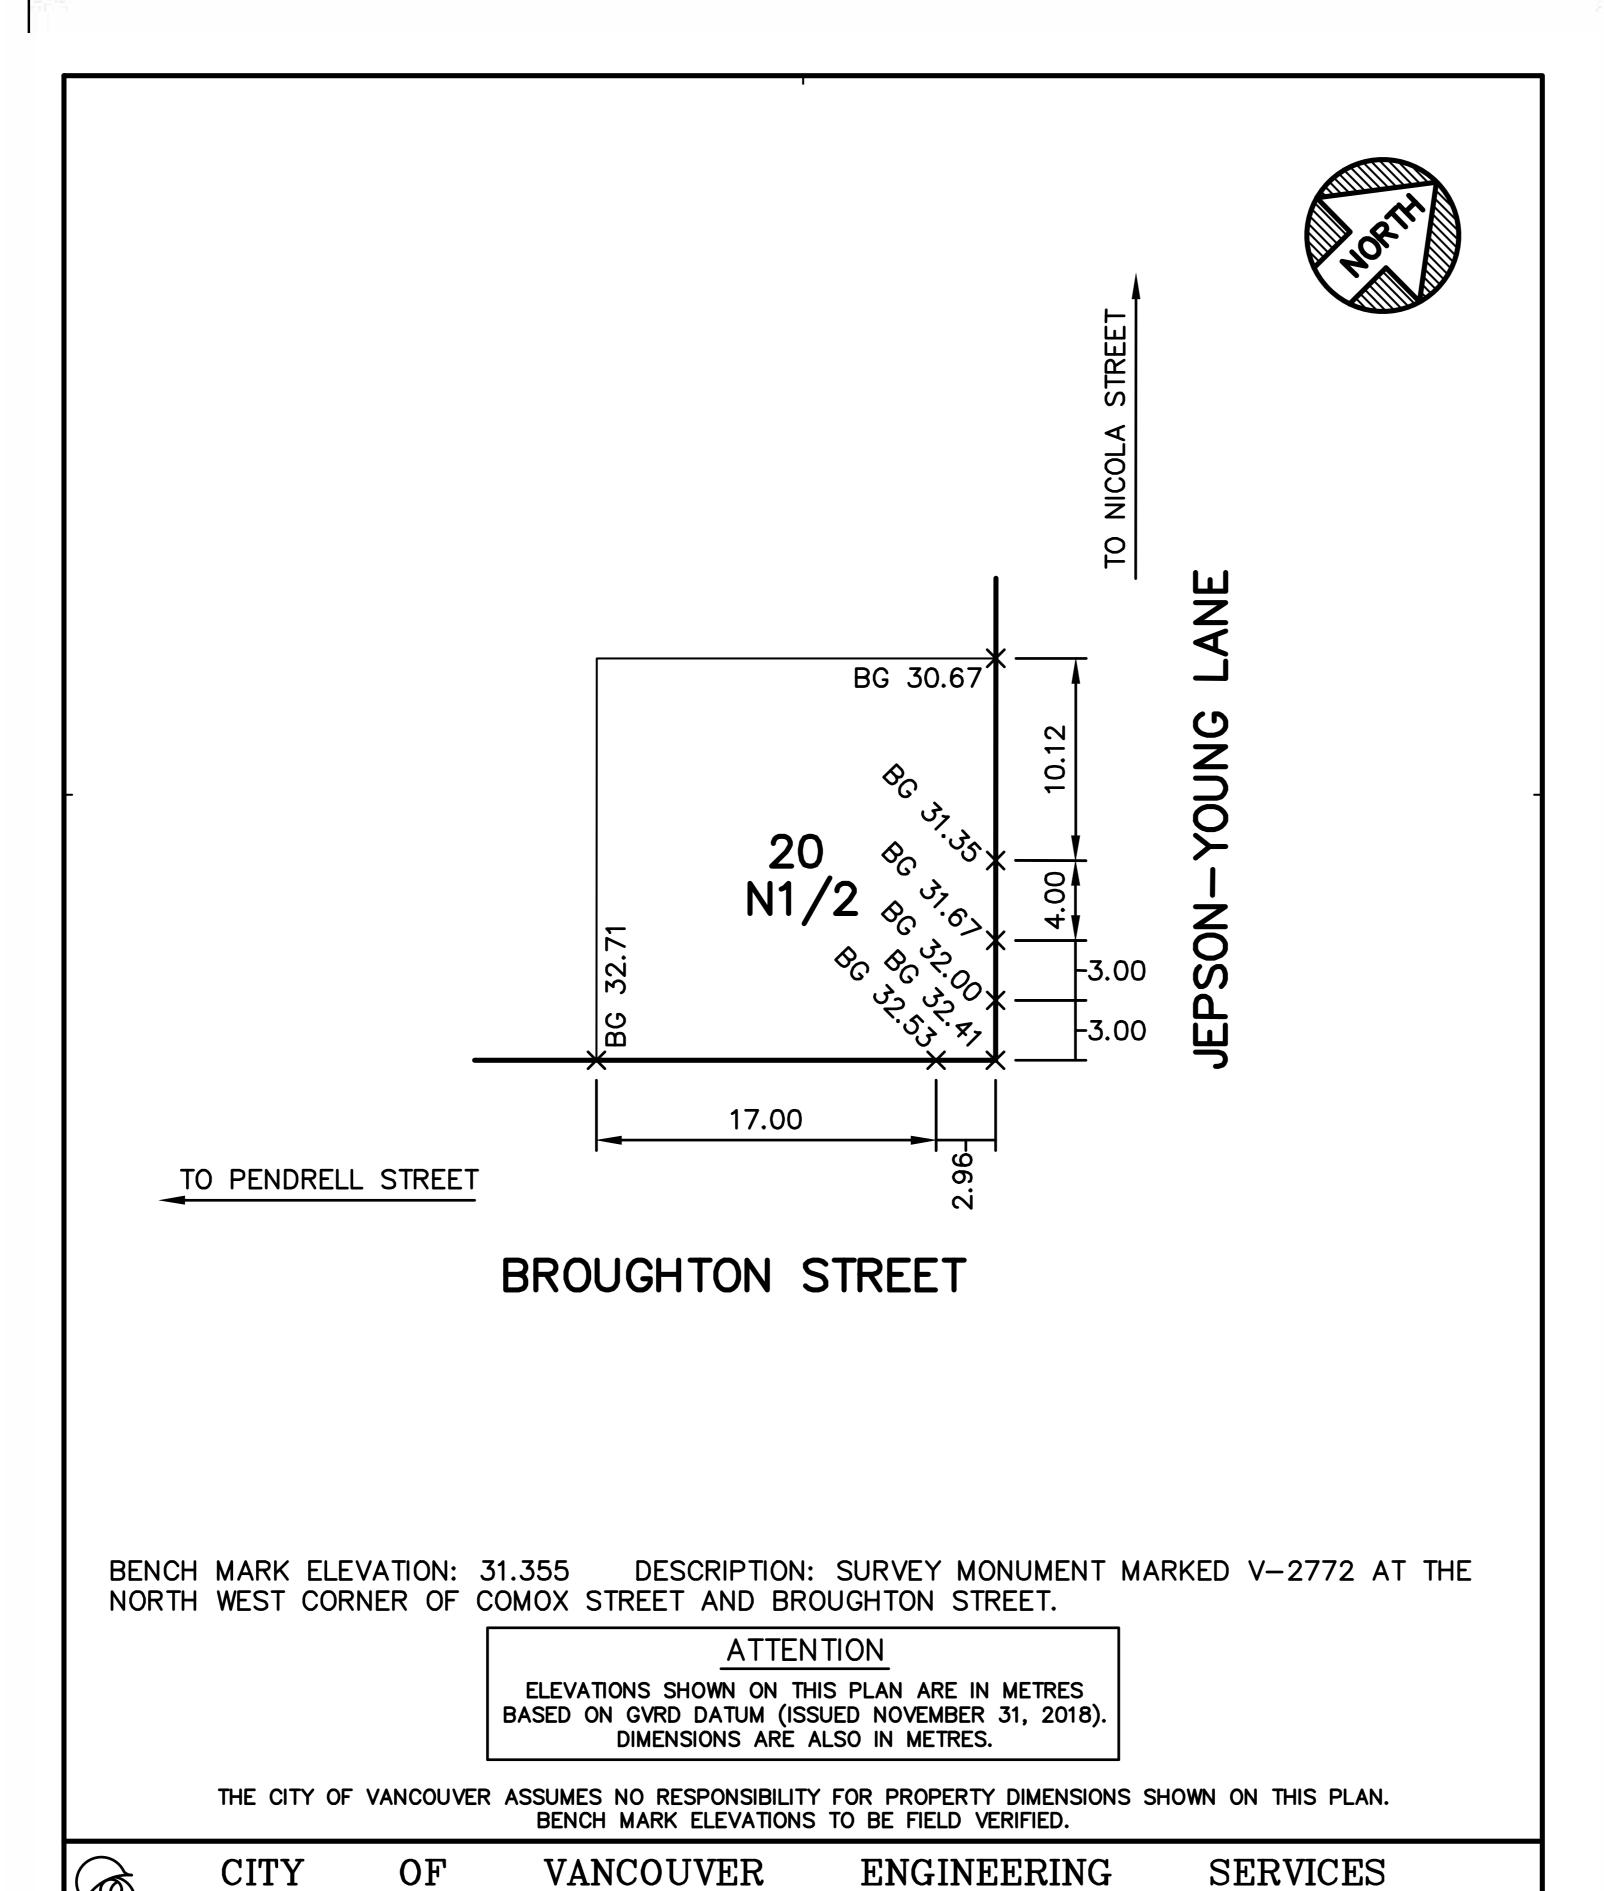
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PROJECT MGR:	APPROVED BY:
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148581	

CONTEXT PLAN

SHEET NUMBER A0.03



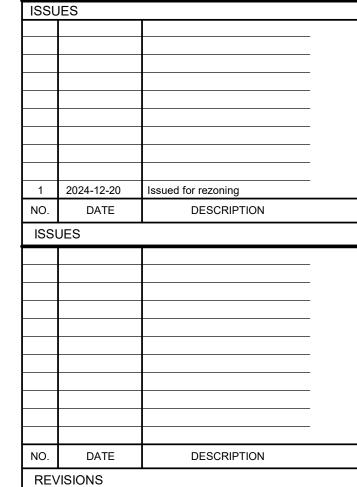

BUILDING GRADE ELEVATIONS

FOR LOT 20 N1/2, BLK. 48,

D.L. 185, PLAN VAP92.

SCALE: 1:400

DATE: 2024-12-02

REF: FILE 2024-00174.

DESIGN: J.D.H. DWG: A.S.

BG-2024-00174

CHK: G.C. REV:

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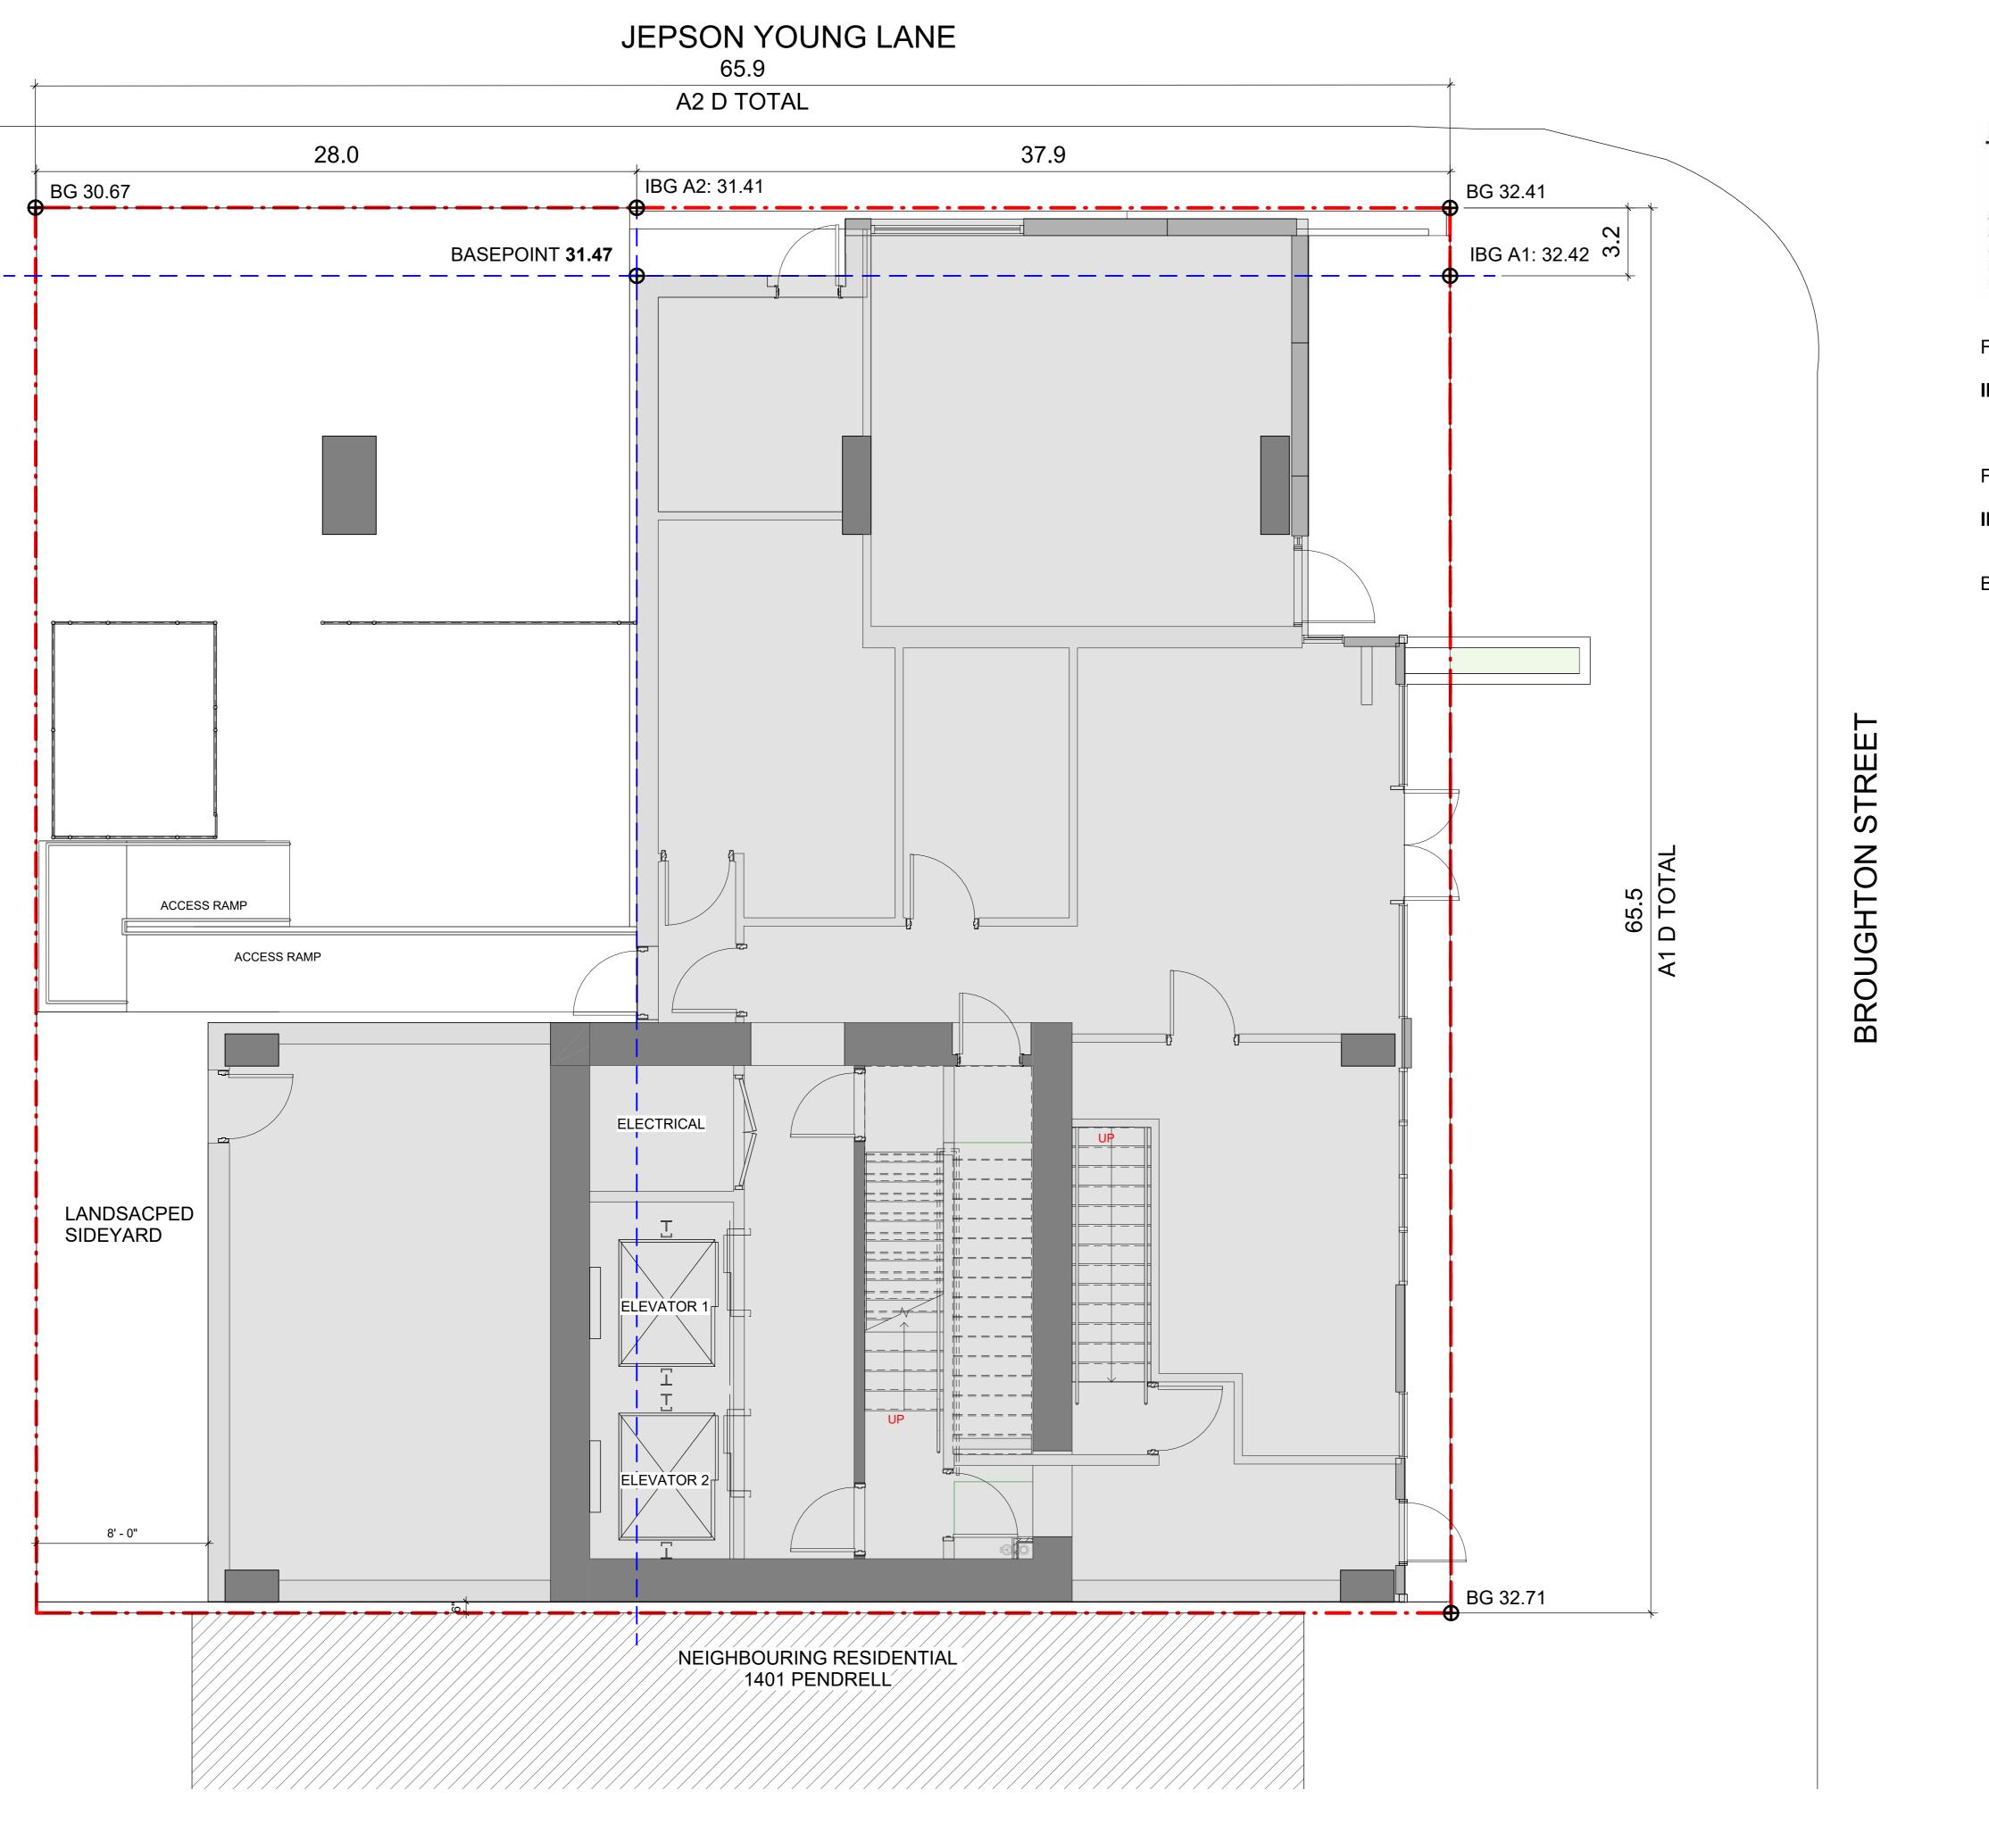
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CITY BUILDING GRADE

ISSUE

SHEET NUMBER A0.05



Base Point Calculations

 $IBG_{x} = \left[\left(\frac{BG_{hlgh} - BG_{low}}{D_{total}} \right) \times D_{low} \right] + BG_{x} + BG_{$

 $BG_{low} = Lower Known Elevation$ $BG_{high} = Higher Known Elevation$

IBG = Interpolated Building Grade

 $D_{low} = Distance \ from \ Lower \ Elevation \ to \ Interpolated \ Building \ Grade$ $D_{total} = Total \ Distance \ from \ Higher \ Known \ Elevation \ to \ Lower \ Known \ Elevation$

FORMULA FOR IBG POINT A1

IBG A1 = $[(32.71-32.41) \times 3.2)$] + 32.41 = **32.42** 65.5

FORMULA FOR IBG POINT A2

IBG A1 = $[(32.41-30.67) \times 28] + 30.67 = 31.40$


BASEPOINT:

= [(32.42-31.40) X 3.2] + 31.40 = 31.47 41.1 CLIEN

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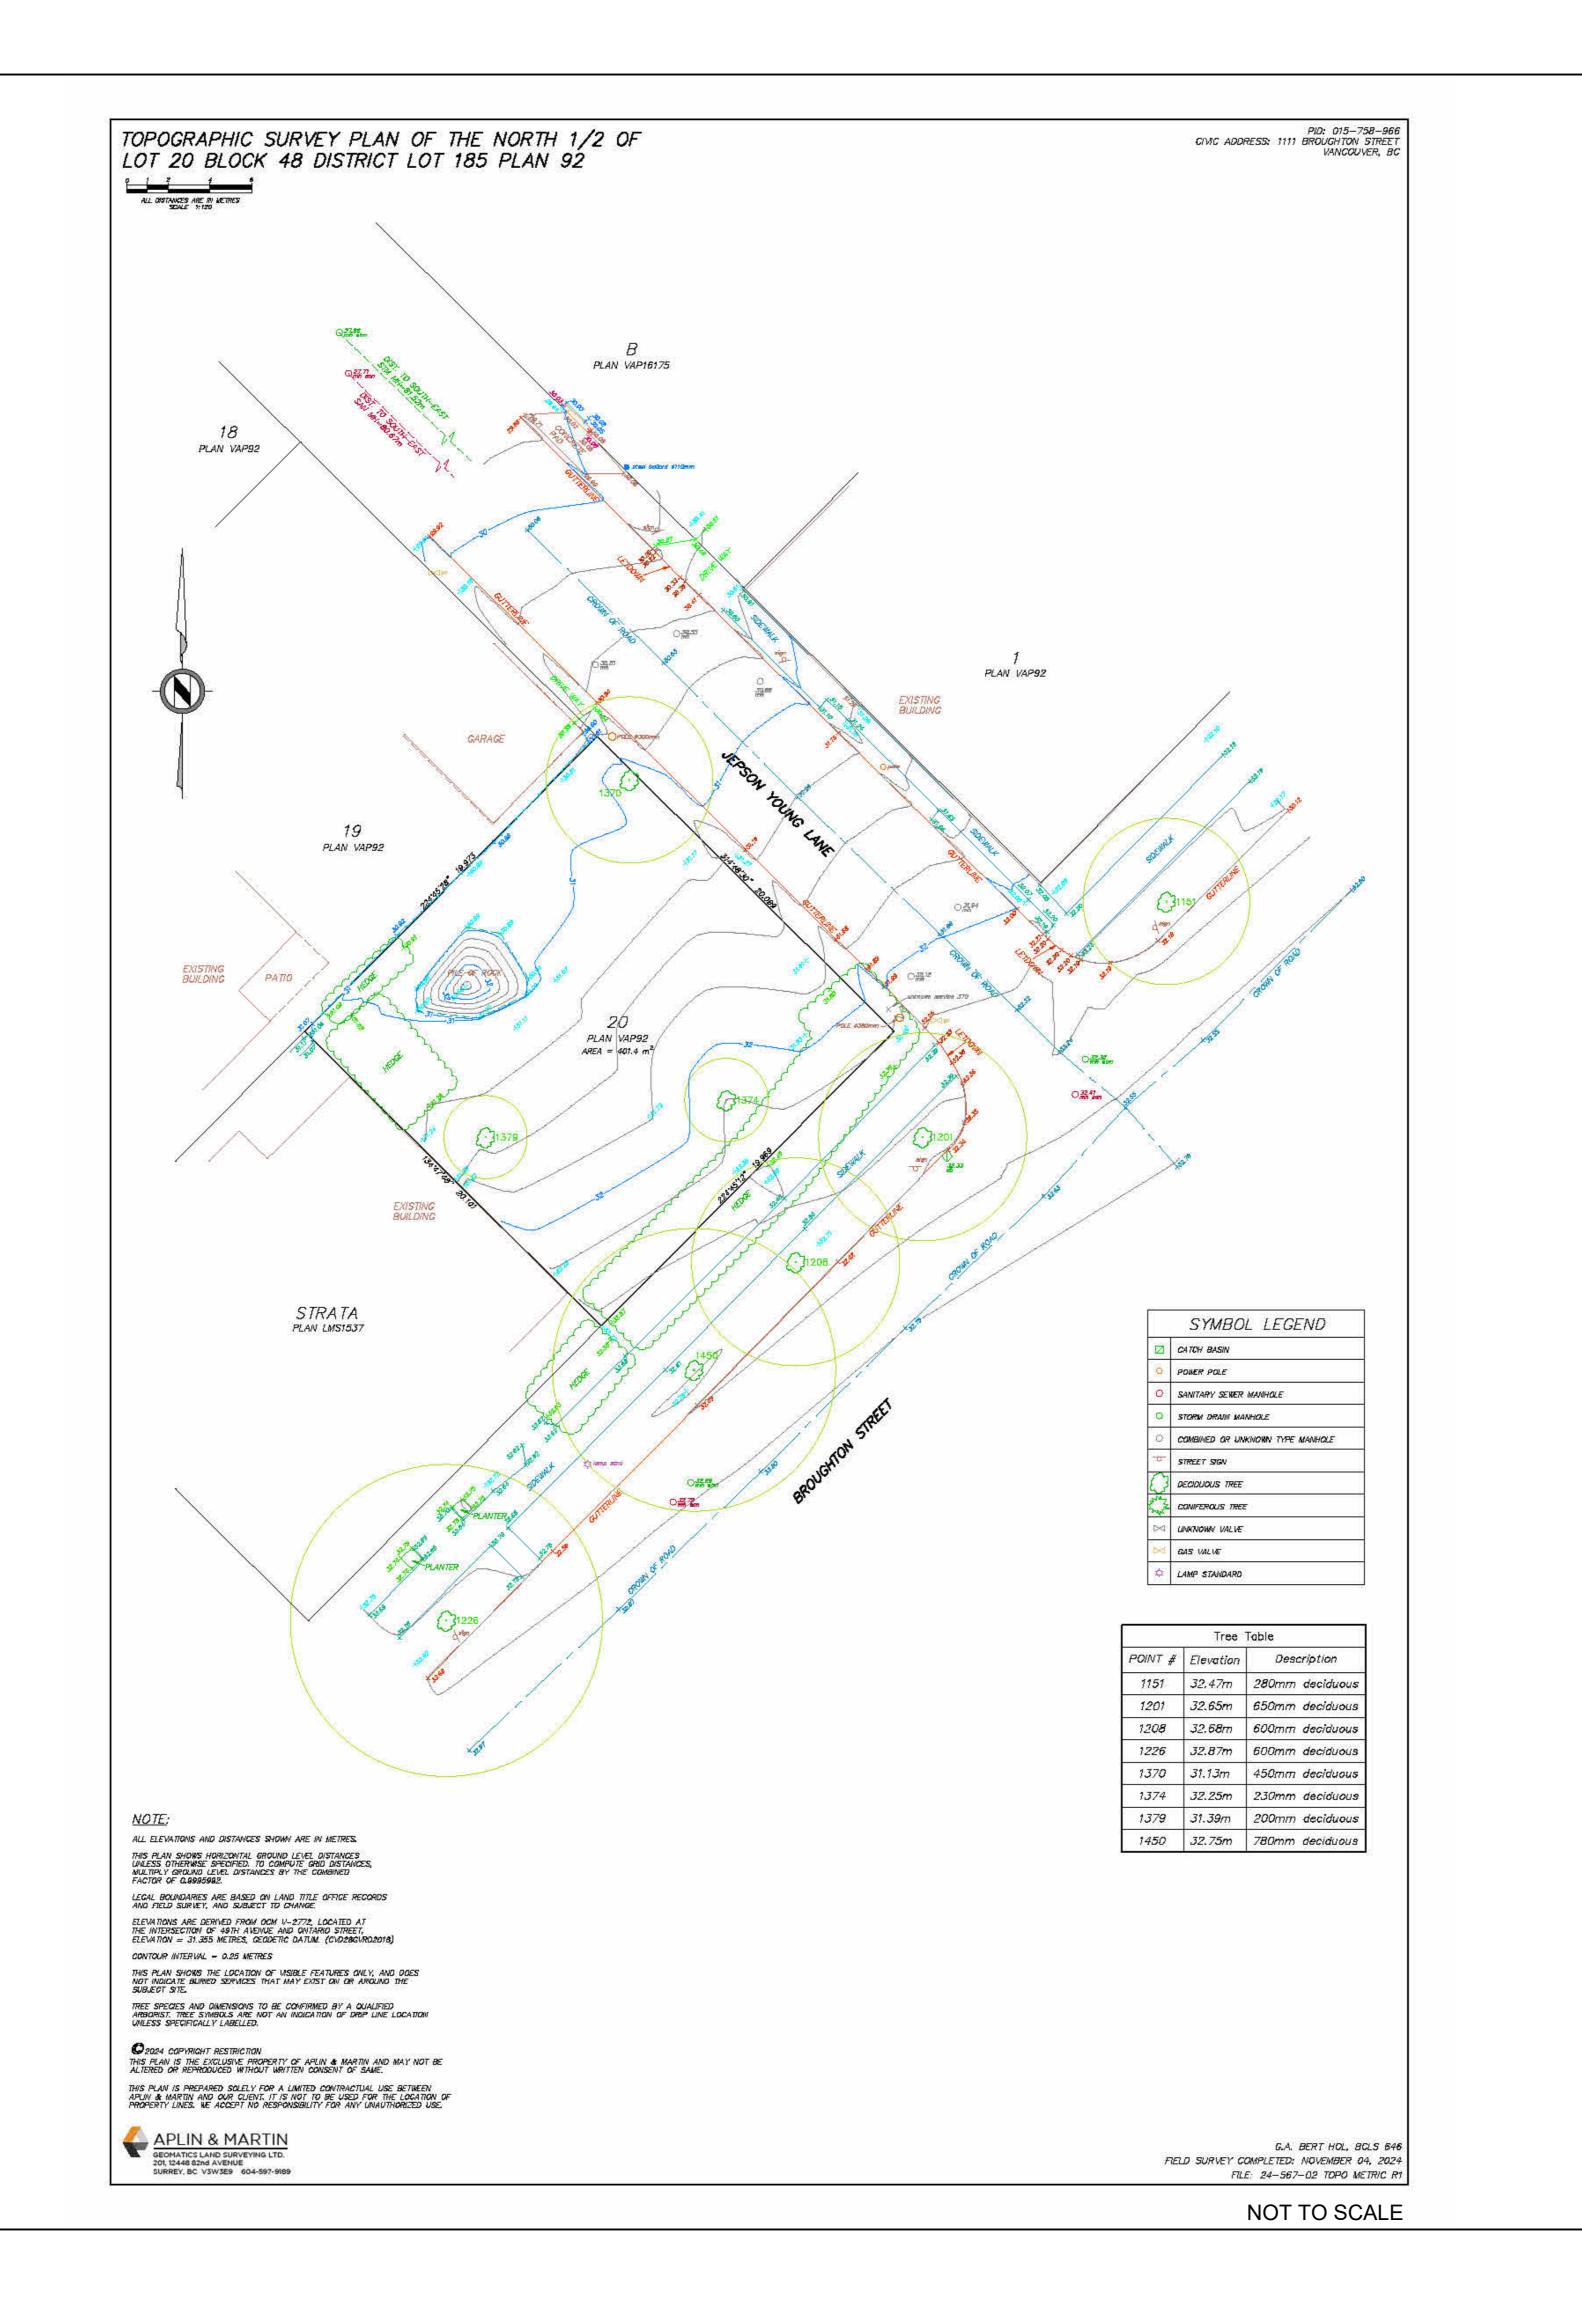
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SHEET TITLE
BASE POINT CALCULATION

SHEET NUMBER

ISSUE
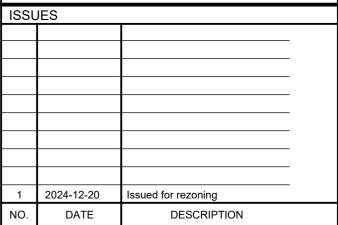
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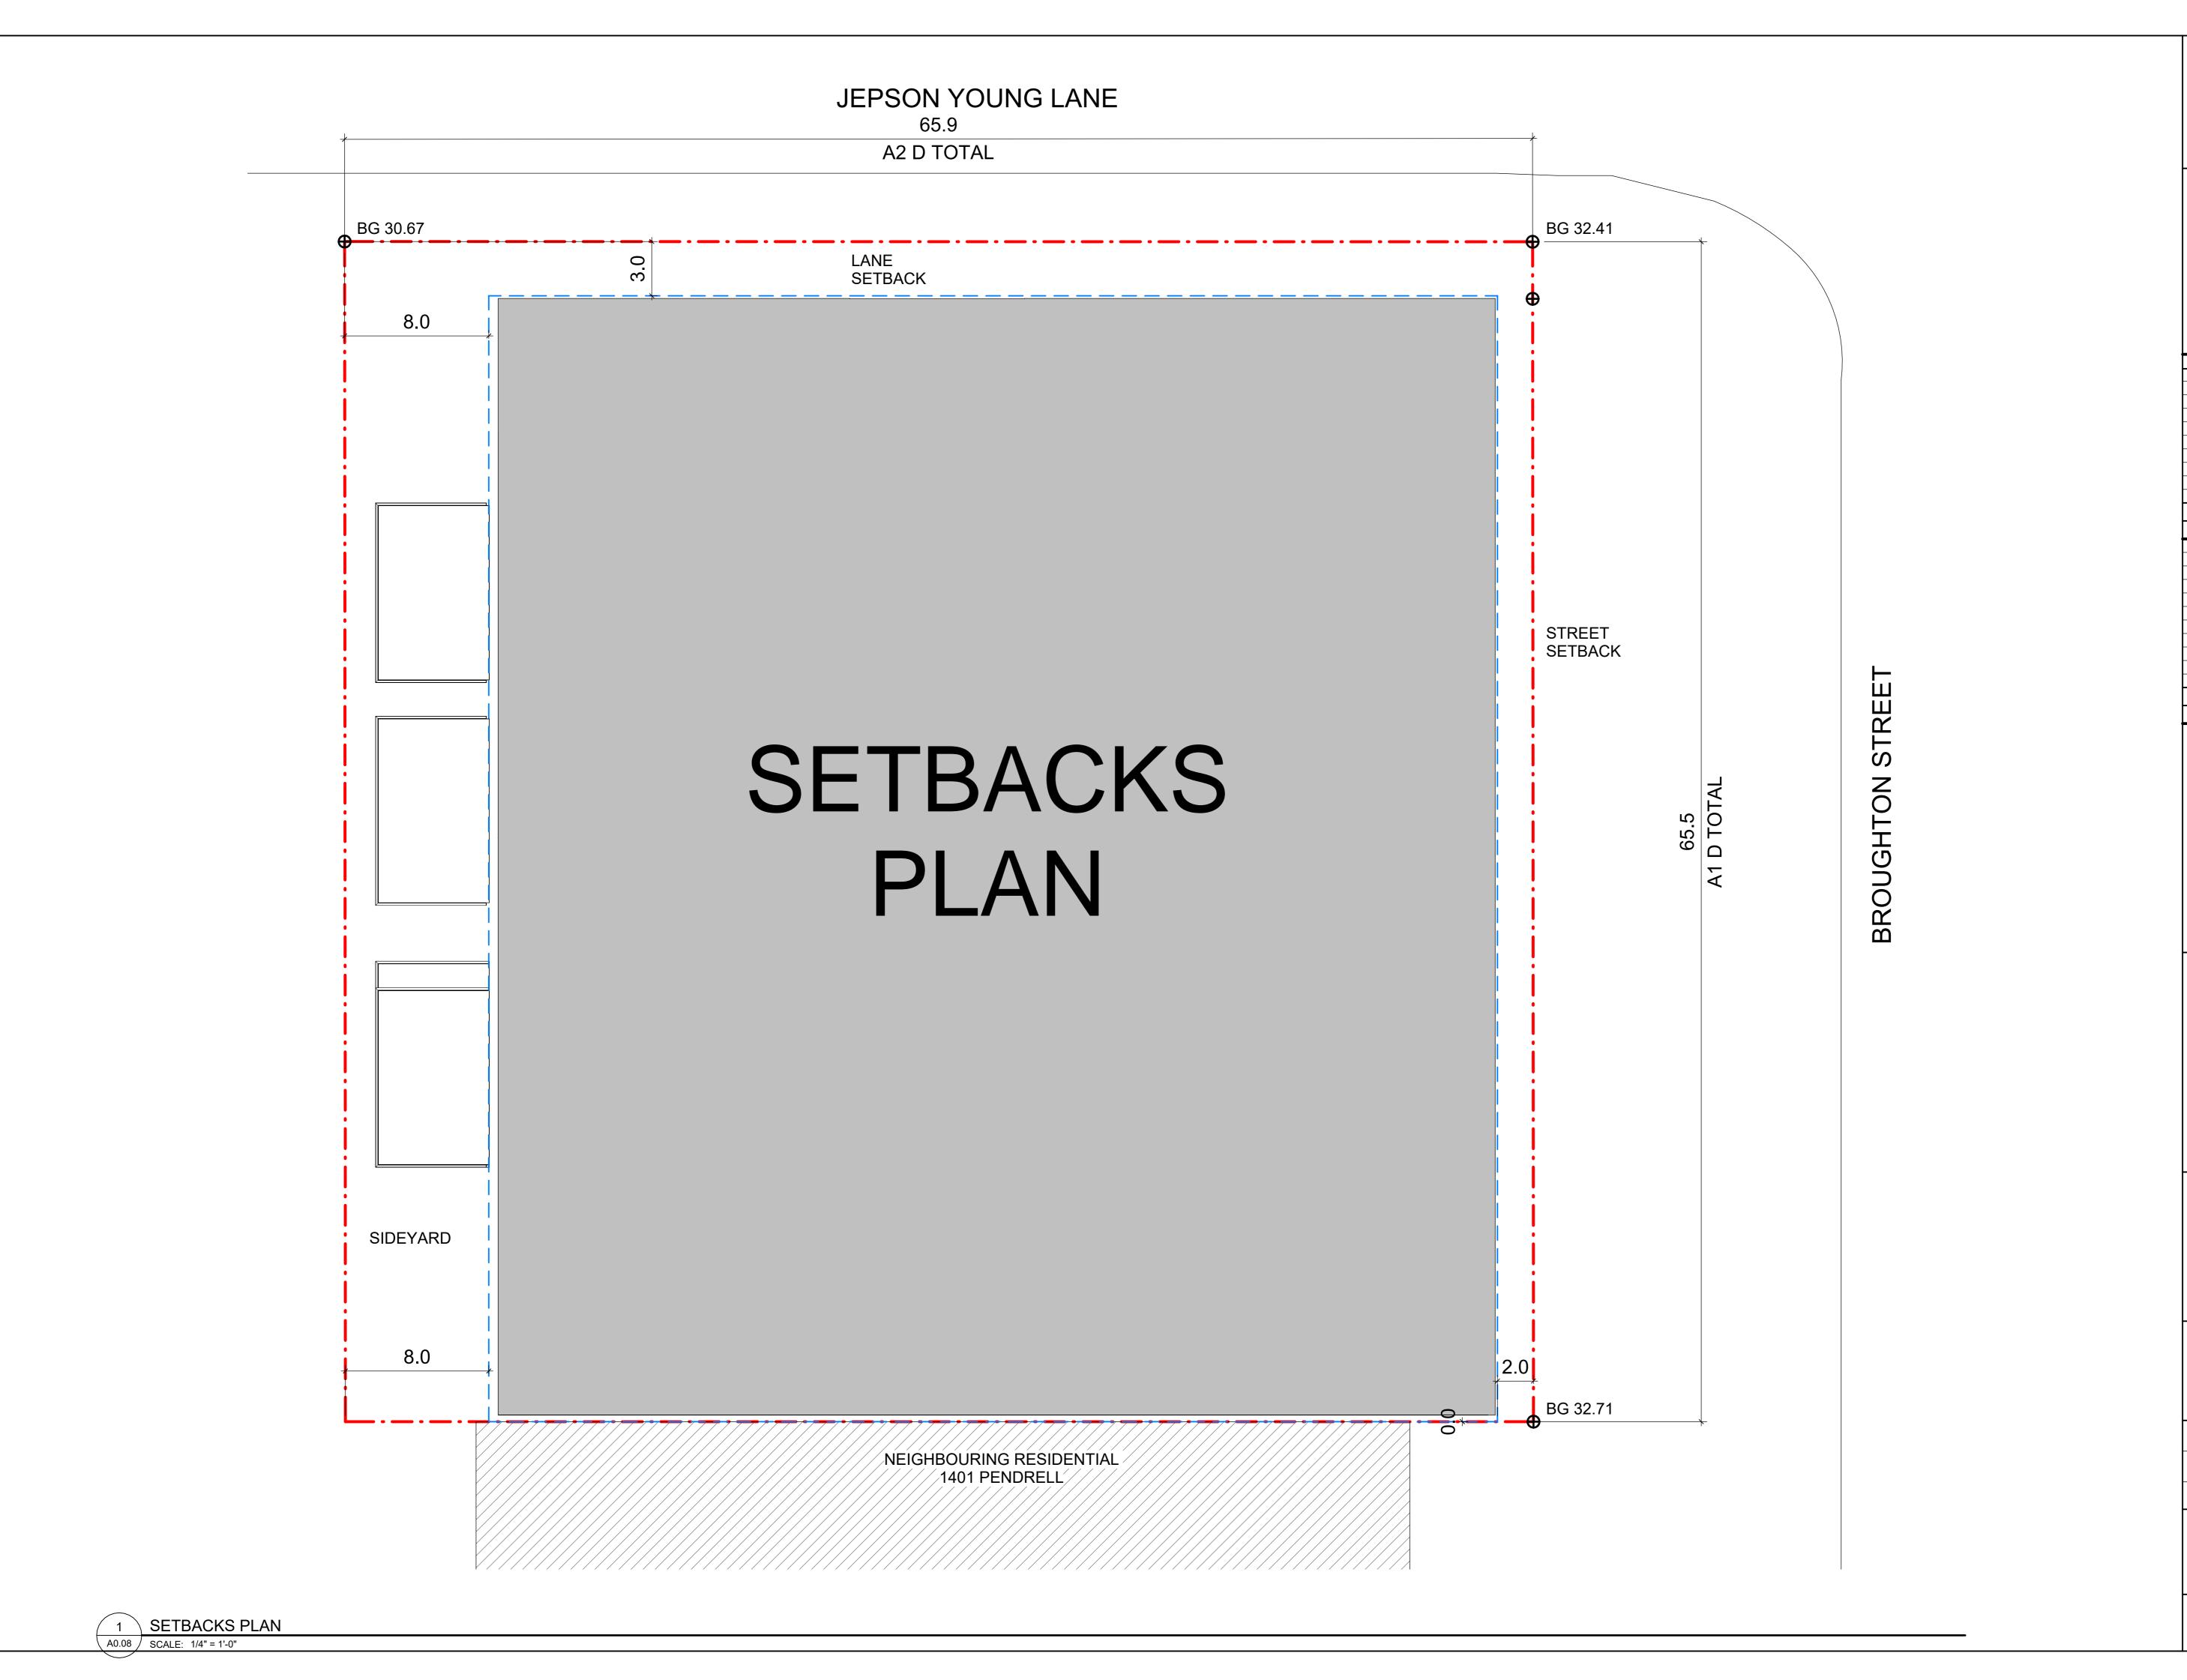
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SHEET TITLE SURVEY PLAN

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SETBACKS PLAN

SHEET NUMBER

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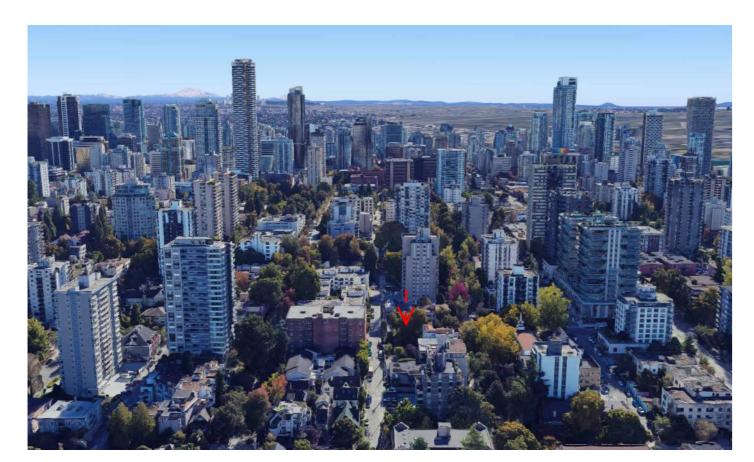
3D FROM BEACH



3D CONTEXT




3D FROM ENGLISH BAY




3D JEPSON YOUNG LANE LOOKING NORTH



AERIAL SITE PLAN

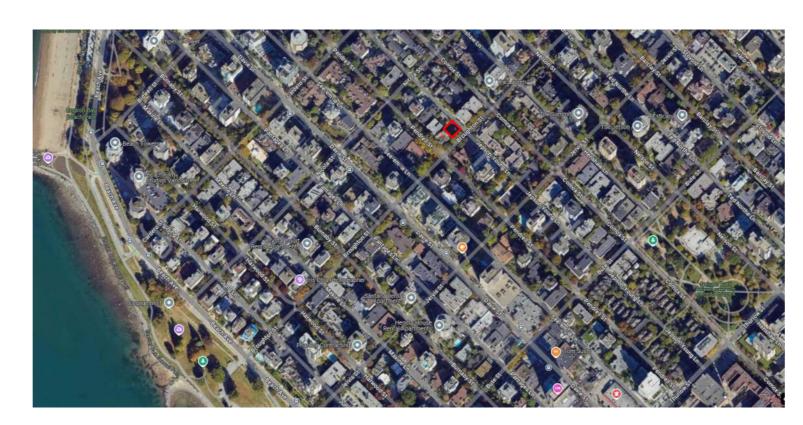

SITE CONTEXT

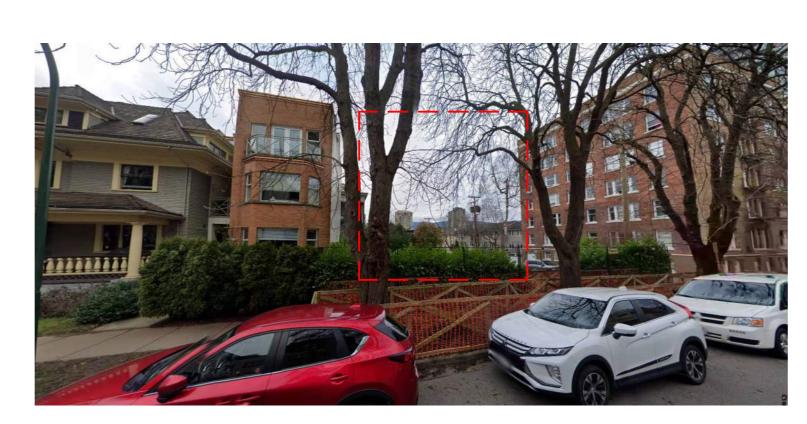


STREETVIEW BROUGHTON LOOKING FRONTAGE



STREETVIEW BROUGHTON LOOKING NORTH EAST



STREETVIEW JEPSON YOUNG LANE LOOKING SOUTH EAST

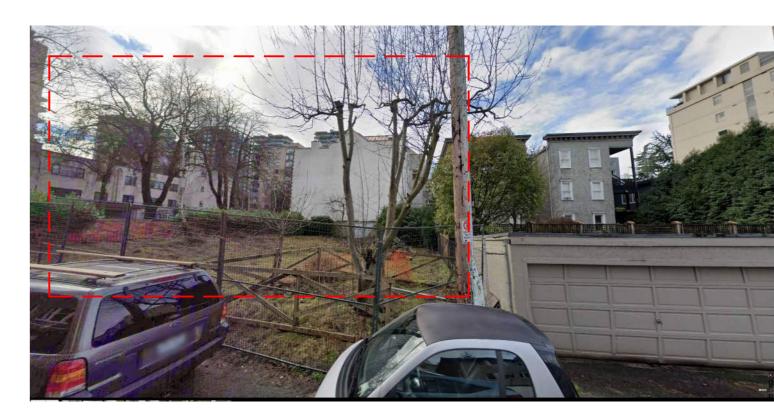

STREETVIEW JEPSON YOUNG LANE LOOKING AT SITE



STREETVIEW BROUGHTON LOOKING SOUTH WEST

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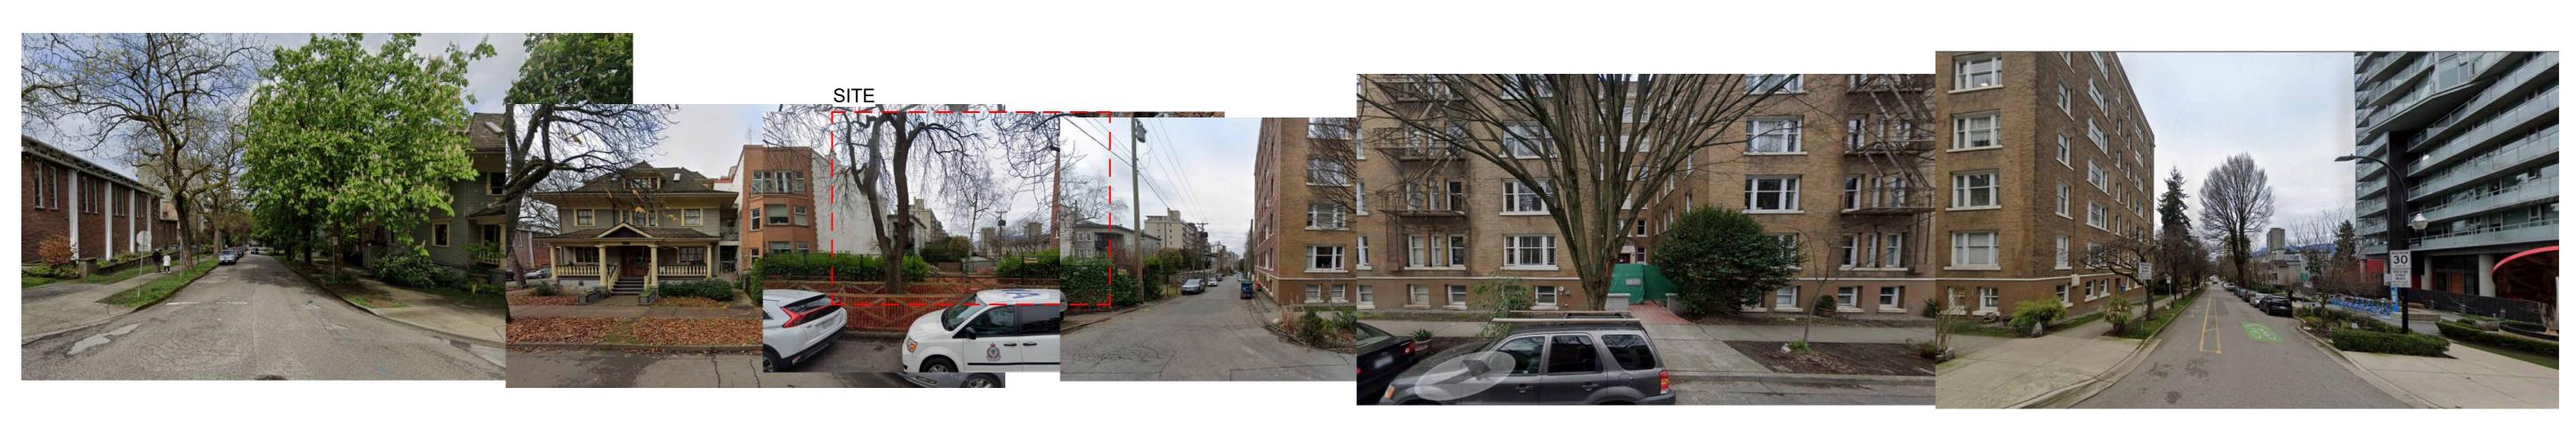
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SHEET TITLE SITE AND CONTEXT PHOTOS

SHEET NUMBER A80.0A



STREET ELEVATION ALONG JEPSON YOUNG LANE



STREET ELEVATION ALONG BROUGHTON STREET

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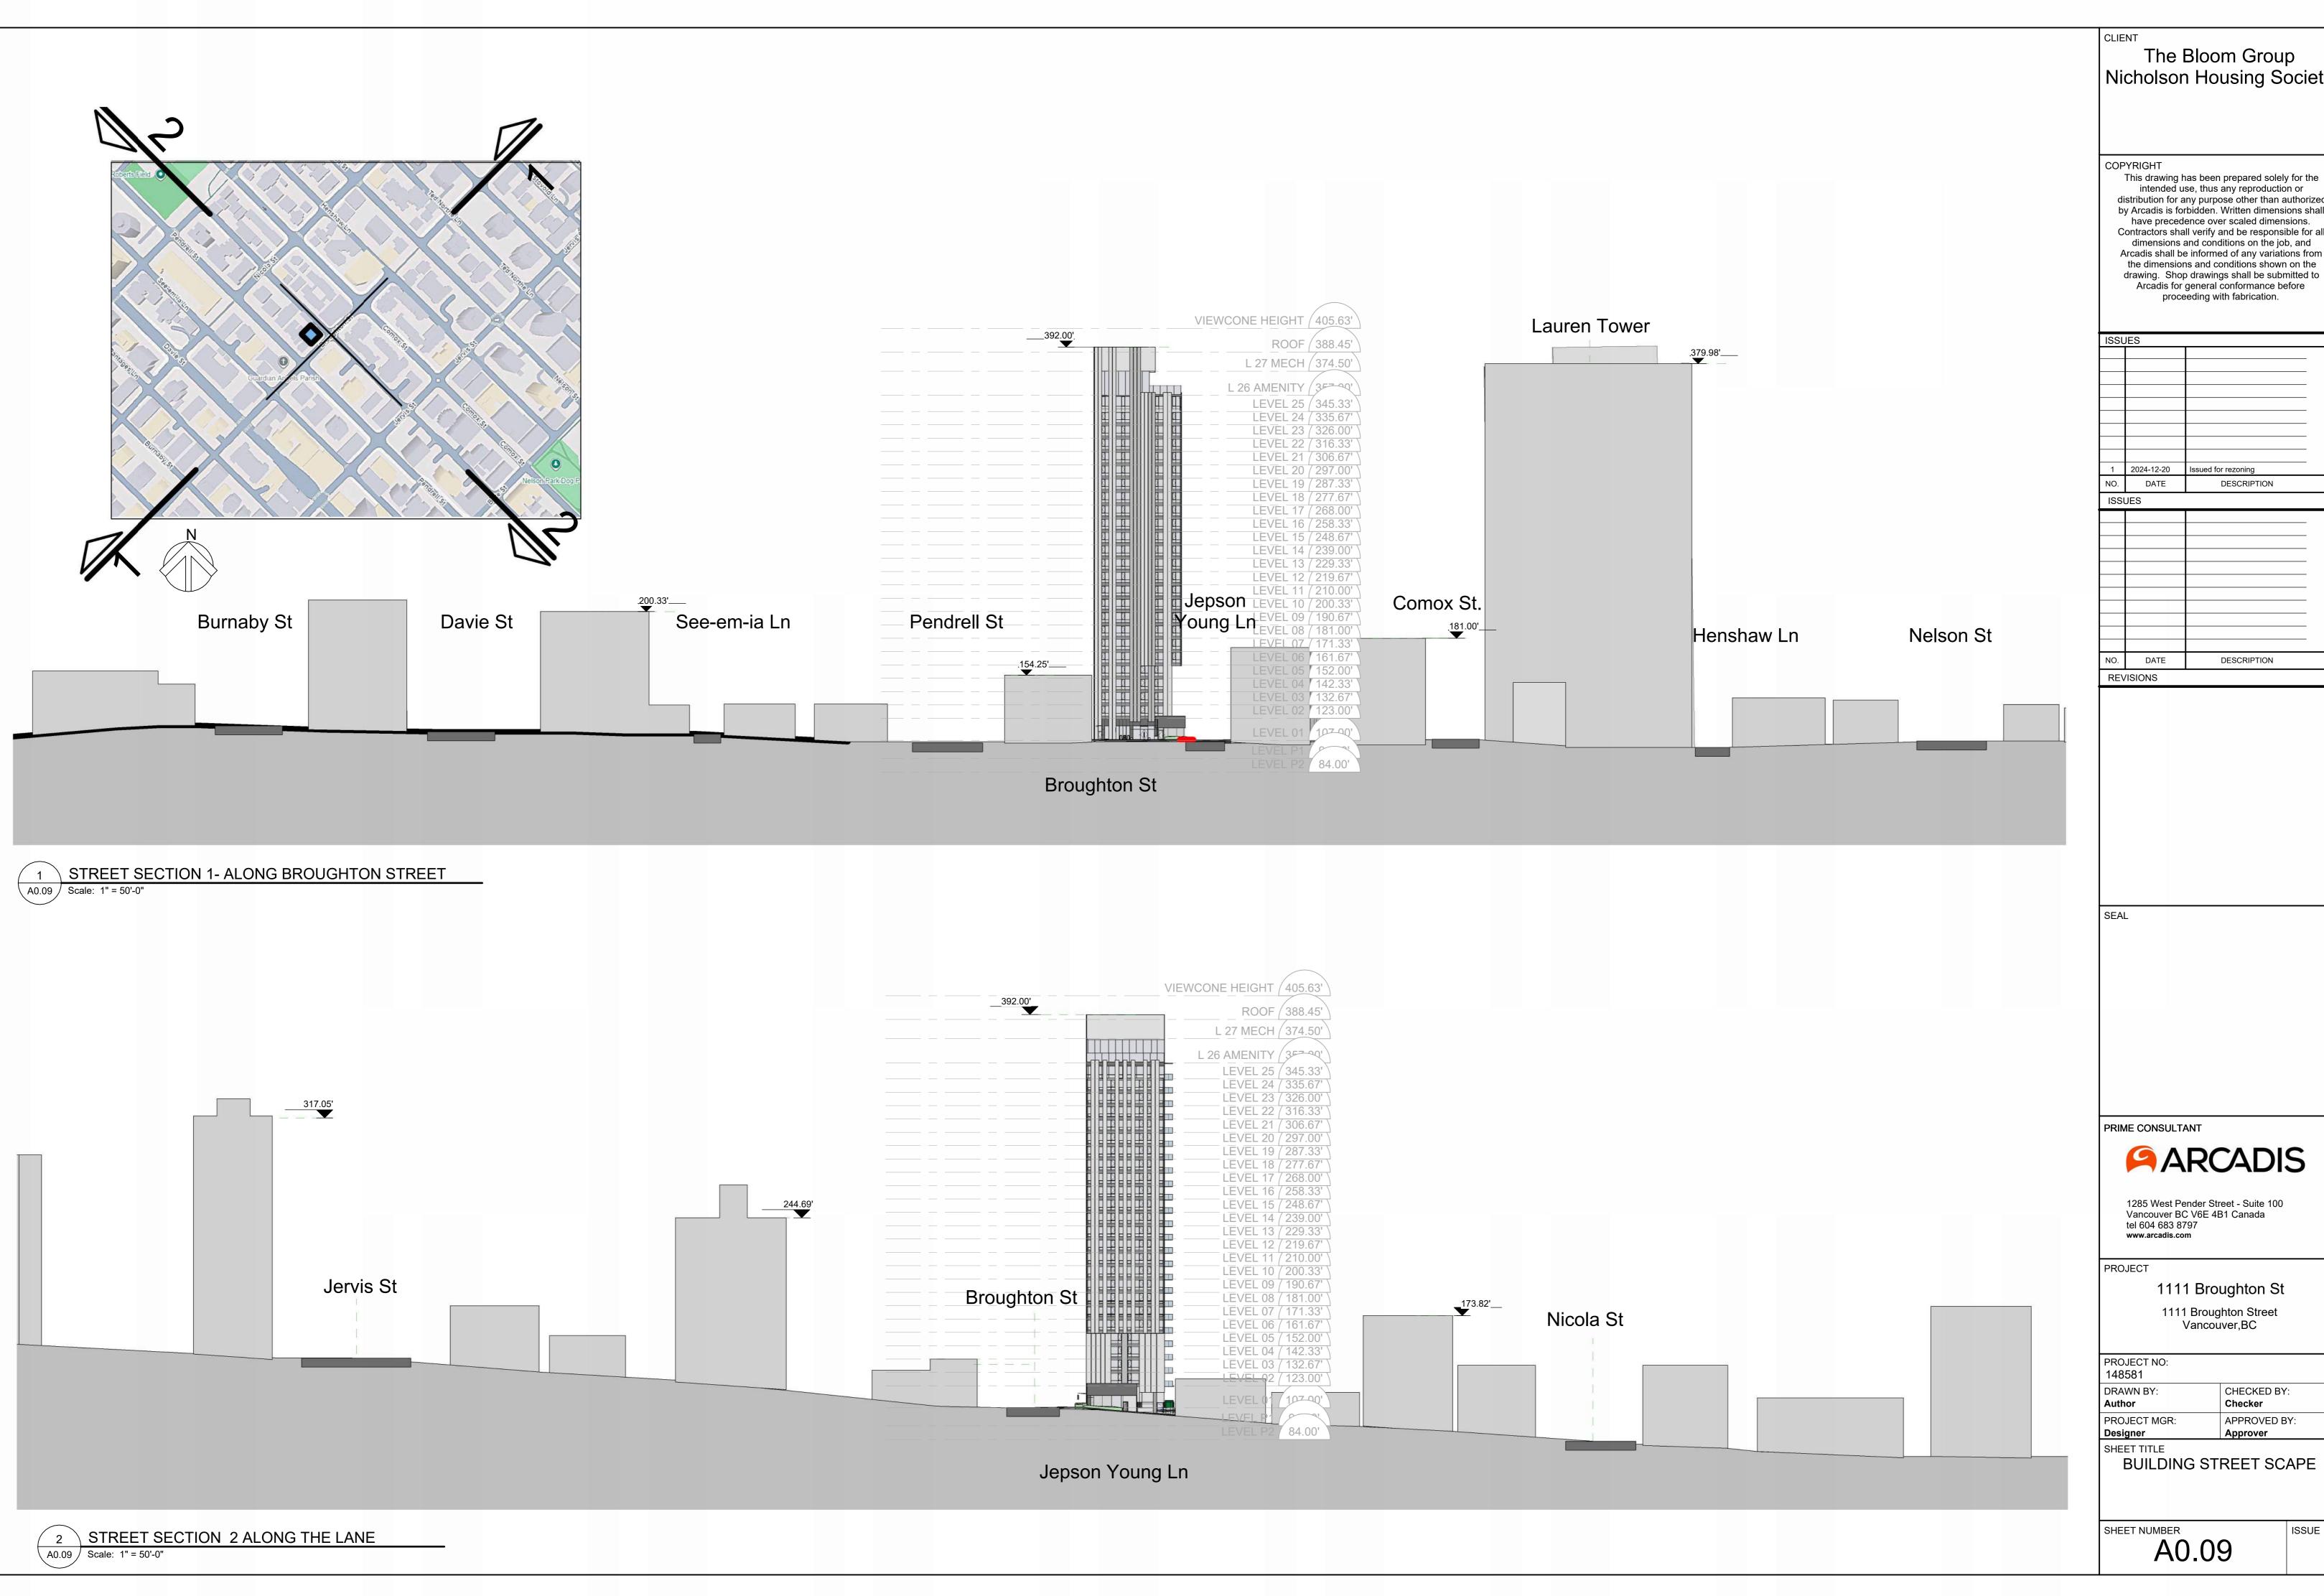
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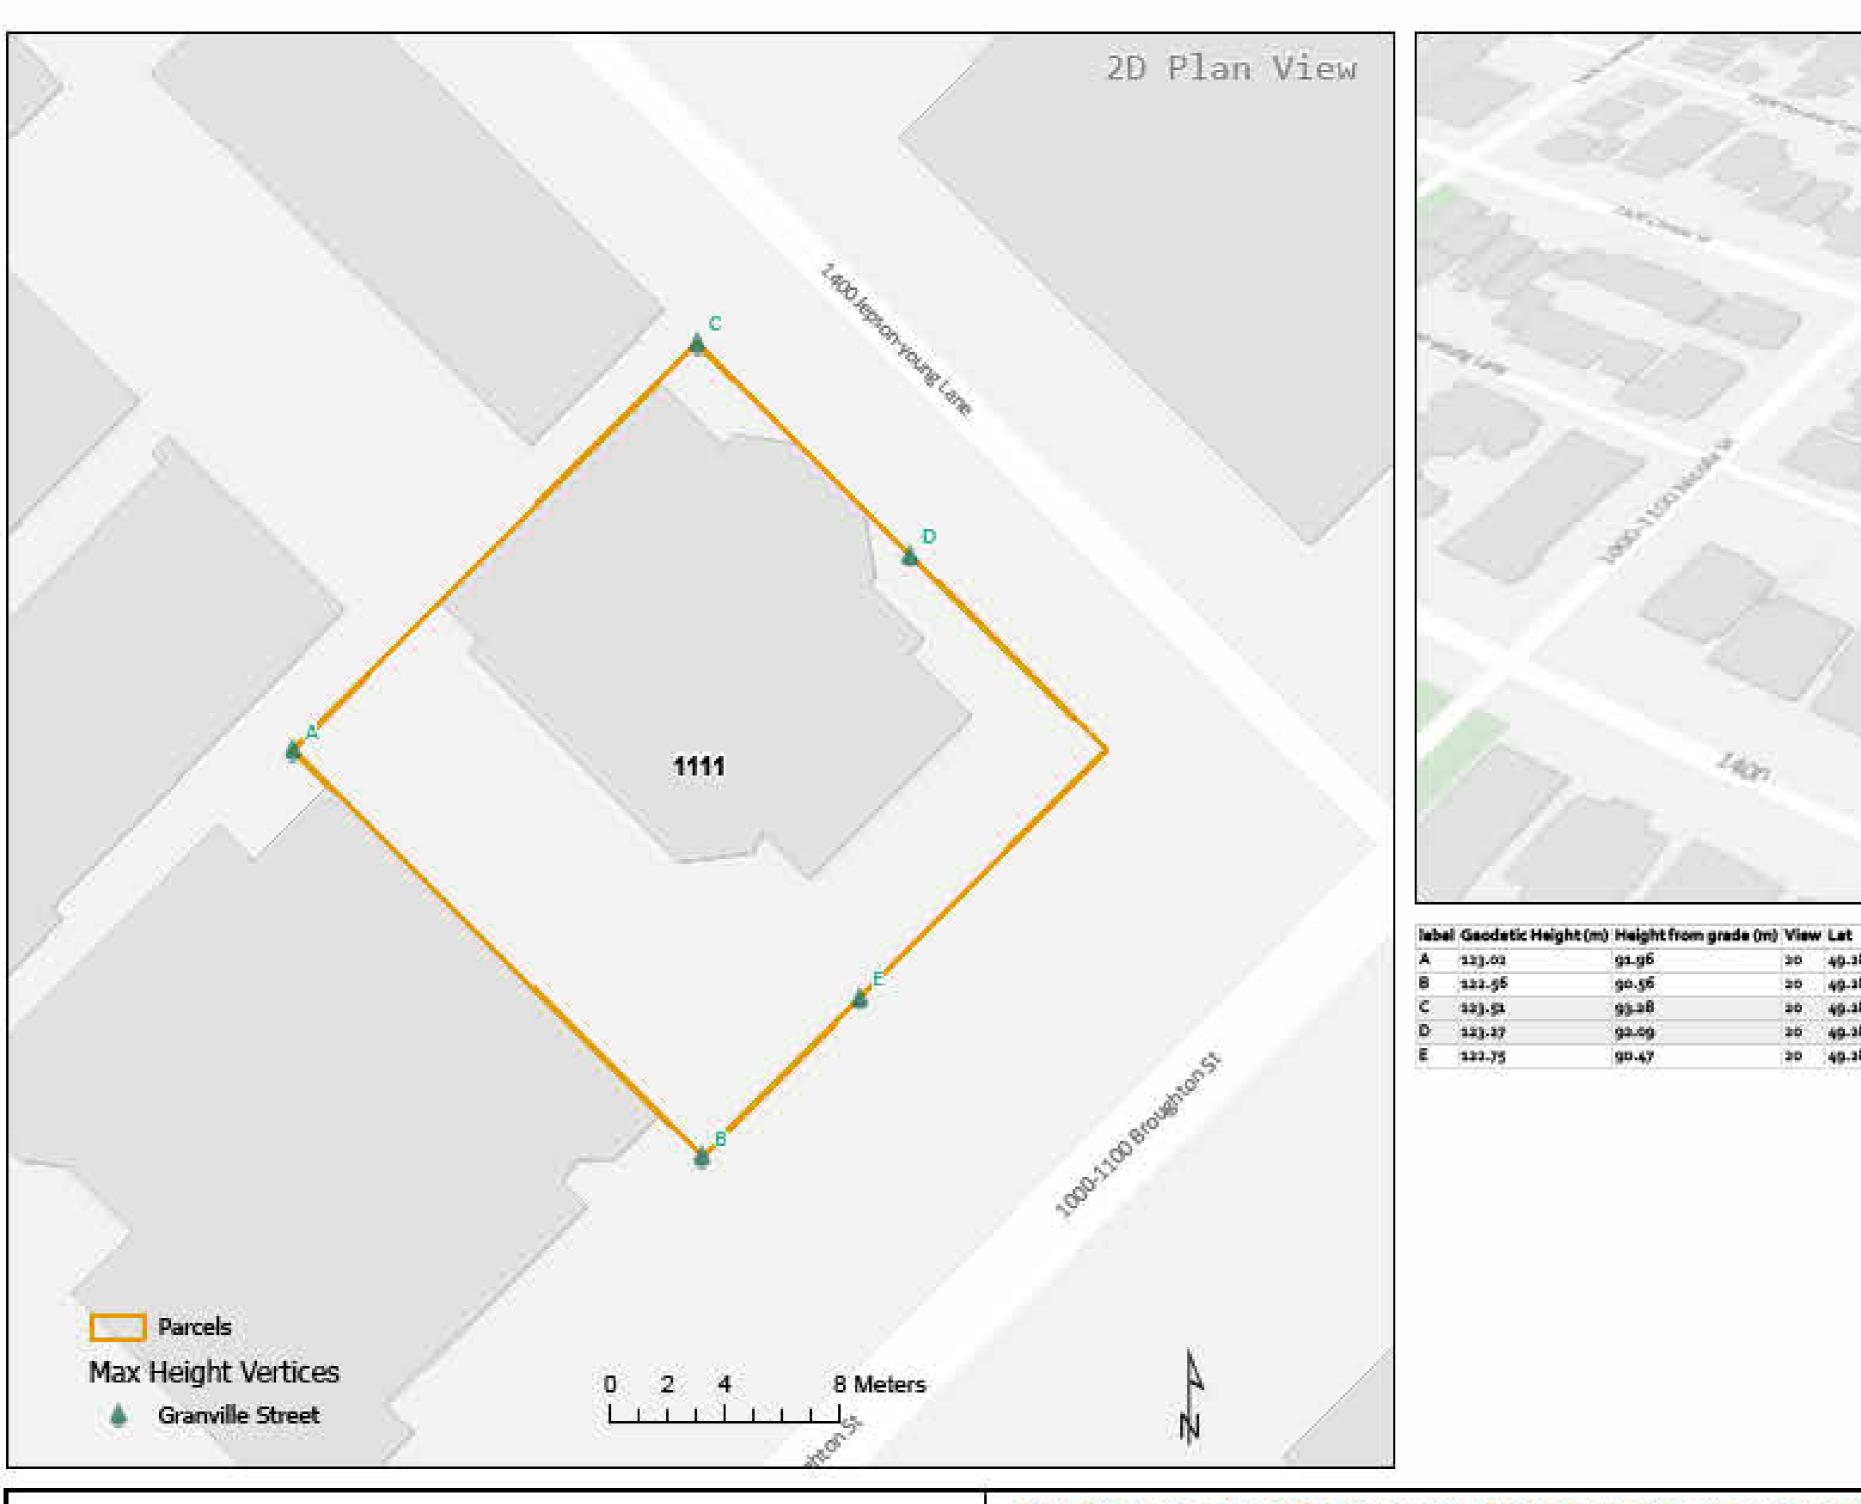
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CHECKED BY: APPROVED BY:

BUILDING STREET SCAPE





Parcel of Interest Wisey Cone Overview Granville 20 49.284653 -223.235056 20 49.284908 -223.235096 20 49.28484 -123.134956 20 49.284702 -123.134979



BASIC VIEW CONE BUILDING HEIGHT LIMITS 1111 Broughton St

The attached View Cone Illustration indicates the approximate height of the most restrictive View Cone(s) above your site.

Only the geodetic heights listed above should be considered definitive. "As building grades can change, the heights from grade listed above are estimated. All parts of the development must be located below this height, including mechanical and other rooftop appurtenances.

The heights noted on the attached illustration supersede any previous advice supplied for this site.

Requested by: Arcadis

Prepared by: SEQ9522

Site IDs: 10972518

View cones limiting the site: 20 - Granville Street

Date: Monday, July 15, 2024 Page No: 1 of 1

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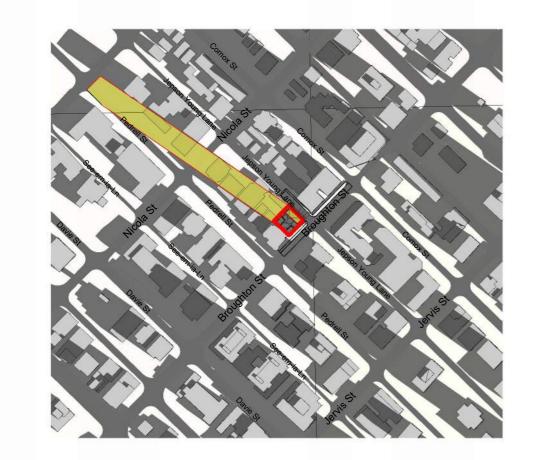
VIEW CONES

APPROVED BY:


ISSUE

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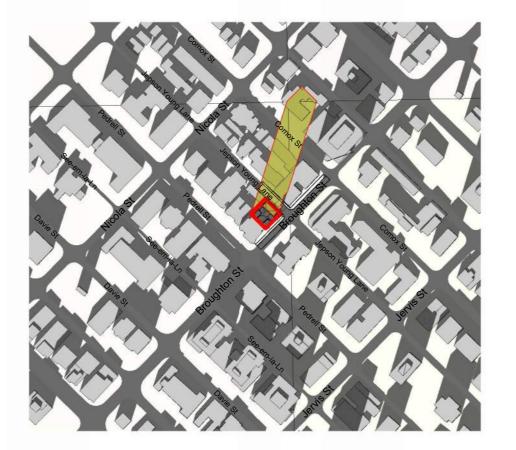
FALL EQUINOX -SEPTEMBER 21st



Sep 21 10:00 am

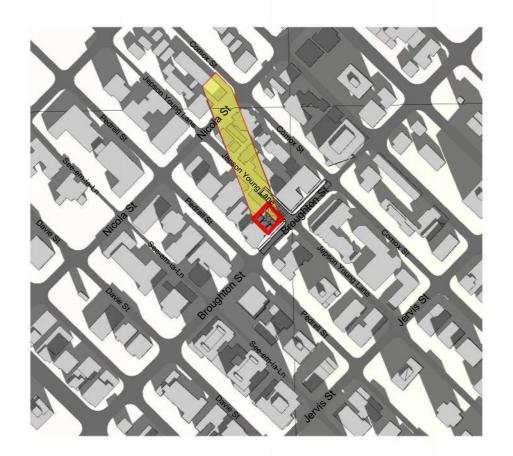


Sep 21 12:00 pm



Sep 21 2:00 pm




Sep 21 3:00 pm

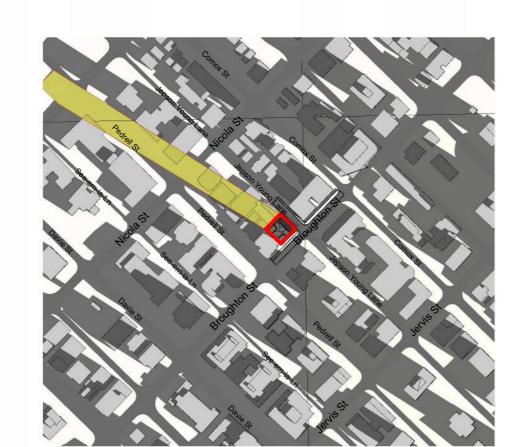


SPRING EQUINOX - MARCH 21st


March 21 10:00 am

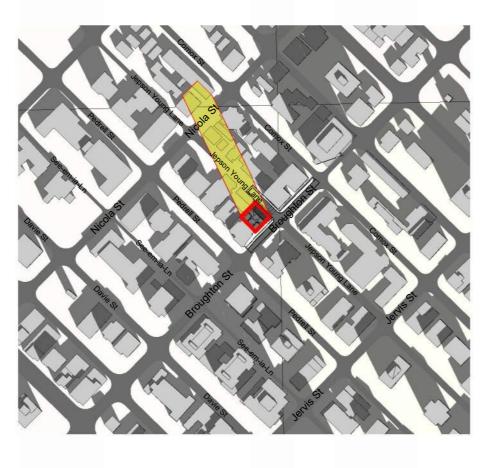

March 21 12:00 pm

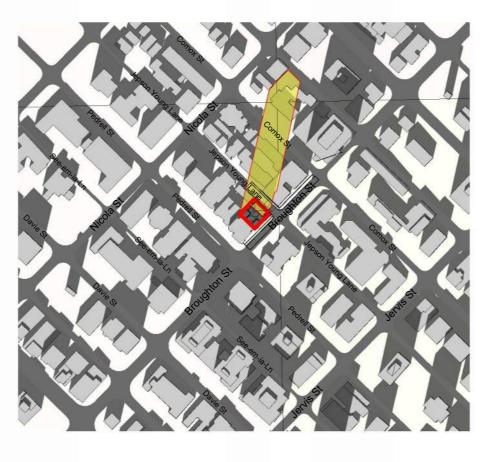

March 21 2:00 pm

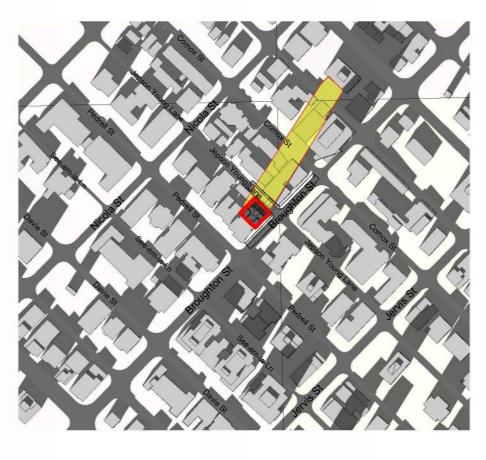

March 21 3:00 pm

SUMMER EQUINOX - JUNE 21st




JUNE 21 10:00 am



JUNE 21 12:00 pm



JUNE 21 2:00 pm

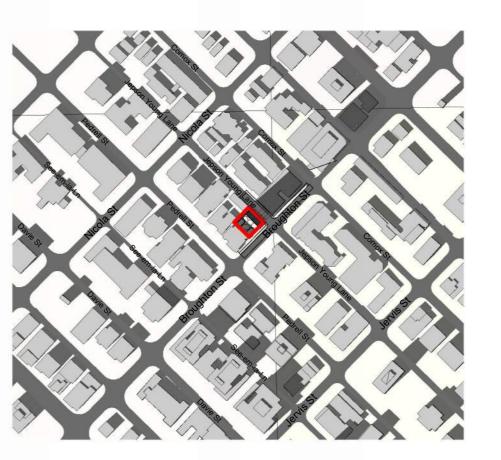

JUNE 21 3:00 pm

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PROJECT NO:
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Designer Approver

SHEET TITLE

SHADOW STUDY

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sheet number A0.12

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PROJECT NO: 148581 DRAWN BY: Author CHECKED BY: Checker PROJECT MGR: APPROVED BY:

Designer
SHEET TITLE

RENDERINGS

SHEET NUMBER A0.13

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2 VIEW FROM SOUTH EAST
A0.14 SCALE:

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1 VIEW FROM NORTH EAST

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BROUGHTON AERIAL

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BROUGHTON STREET

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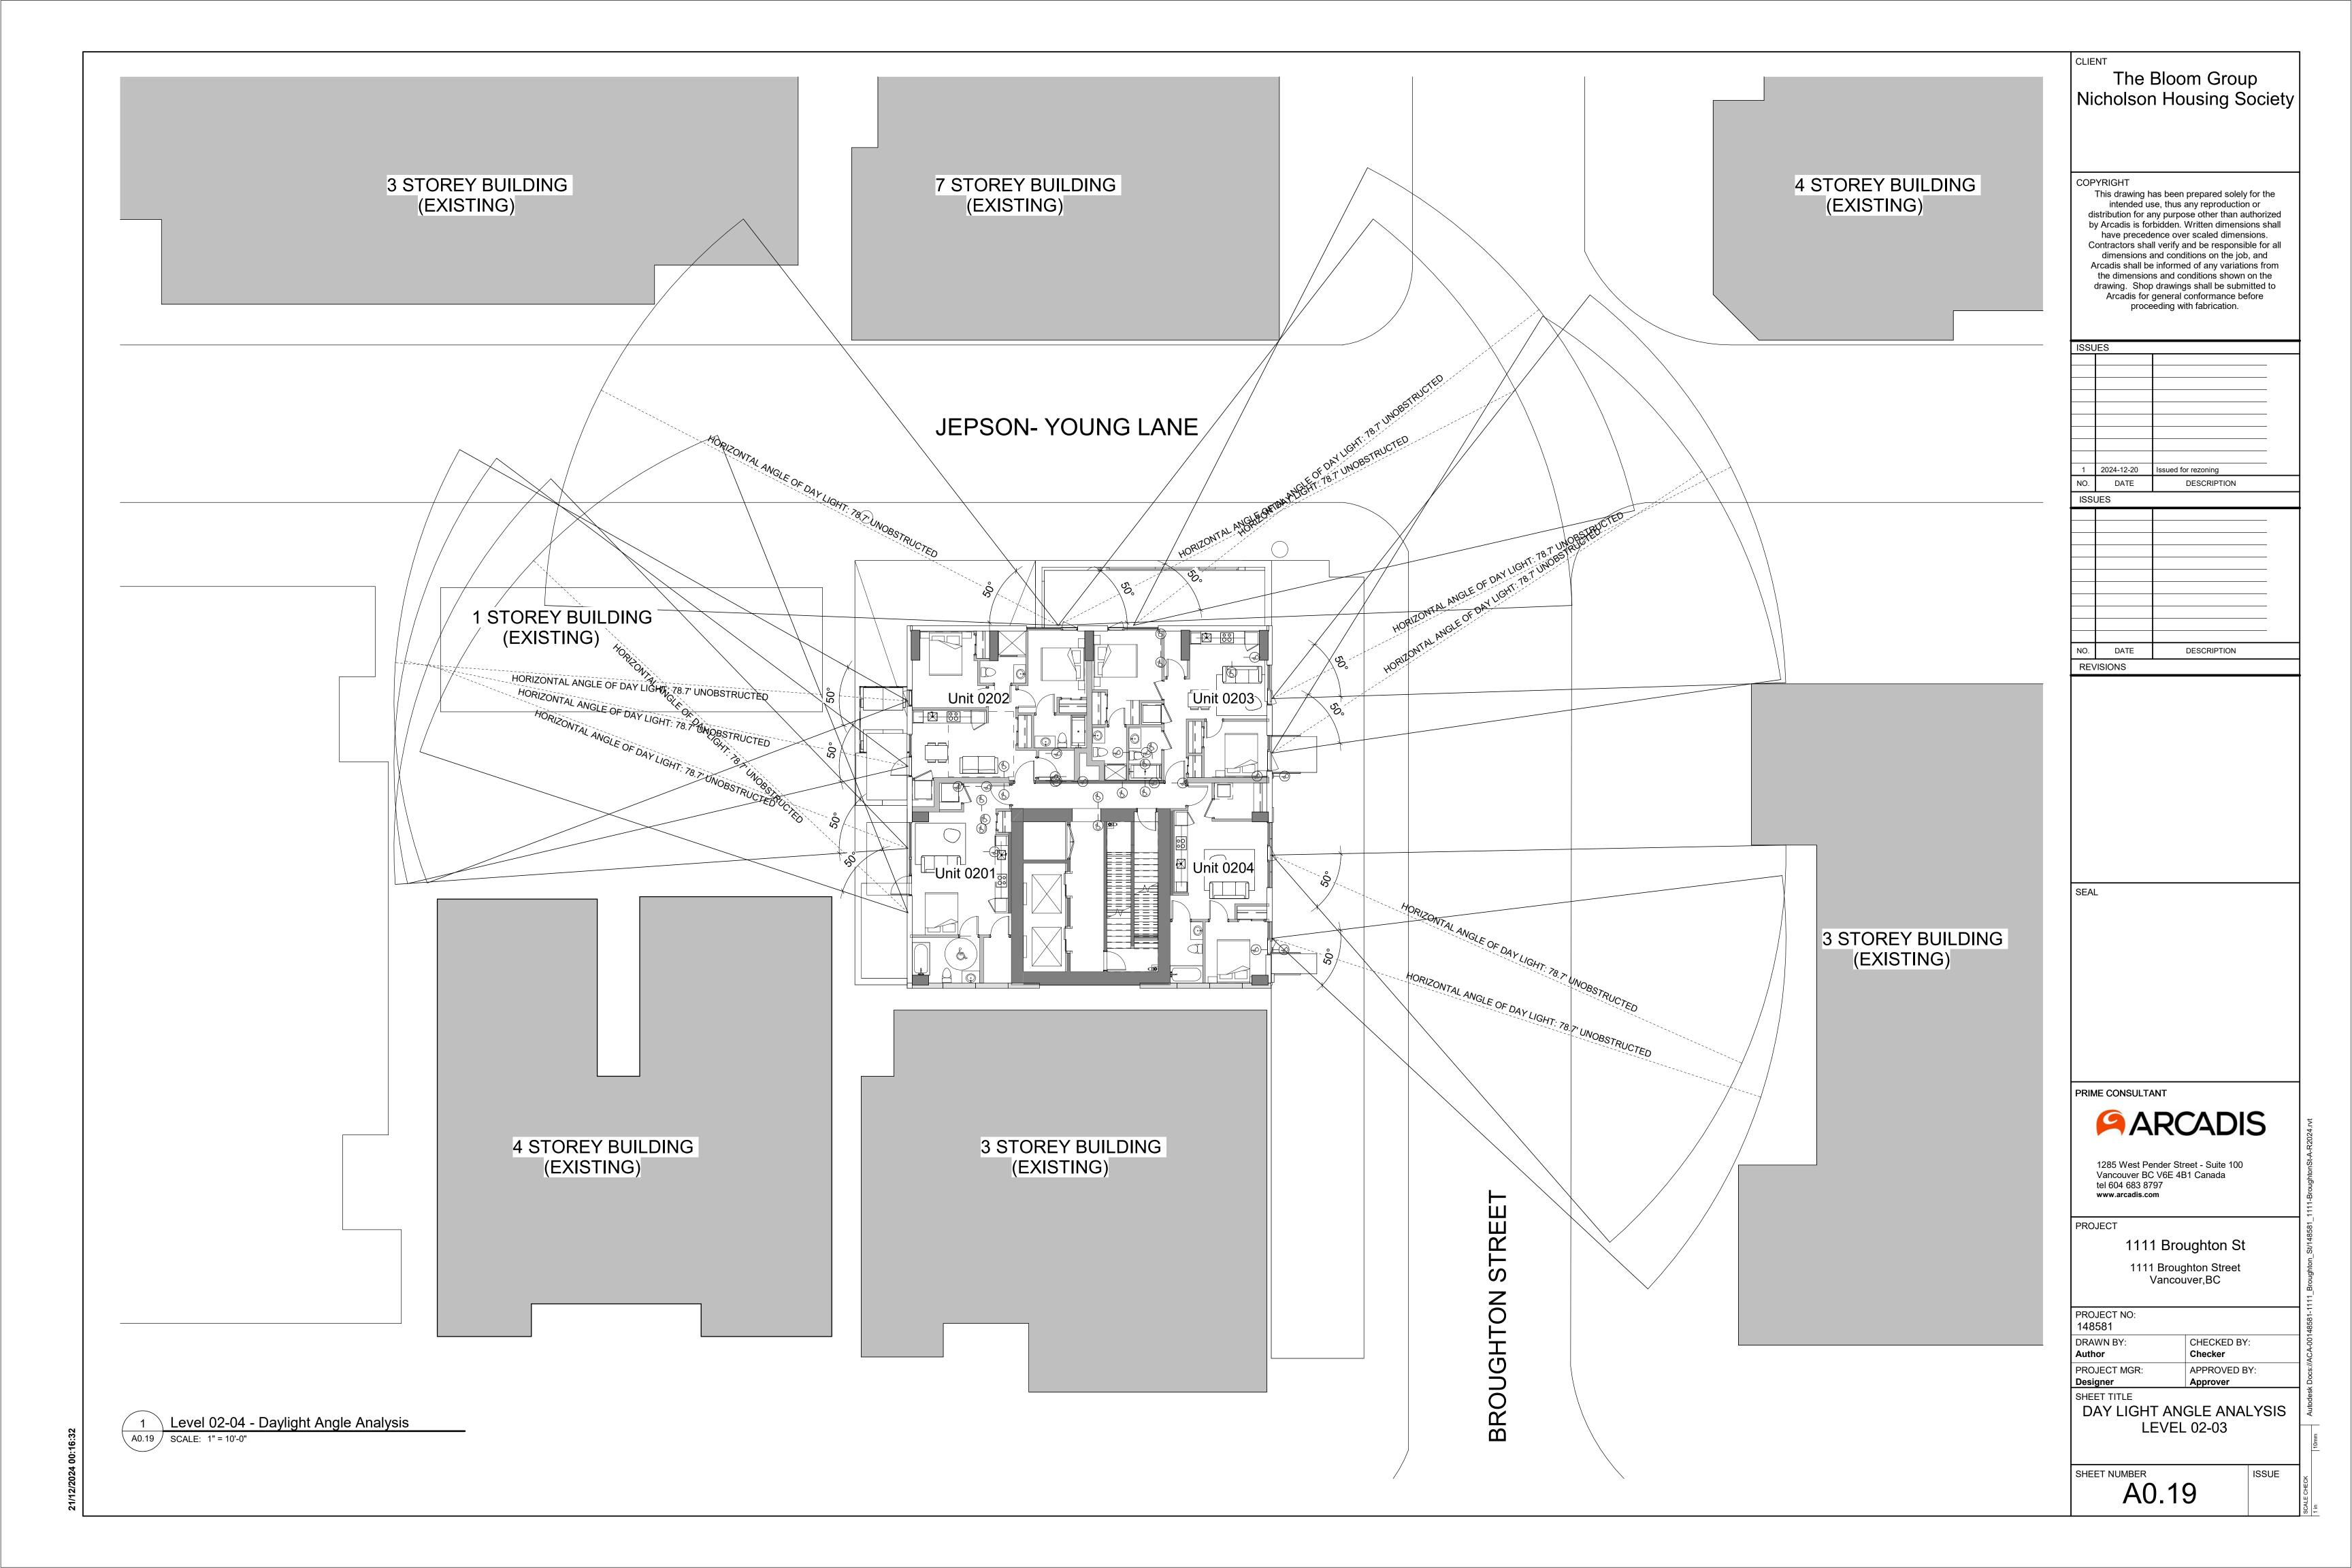
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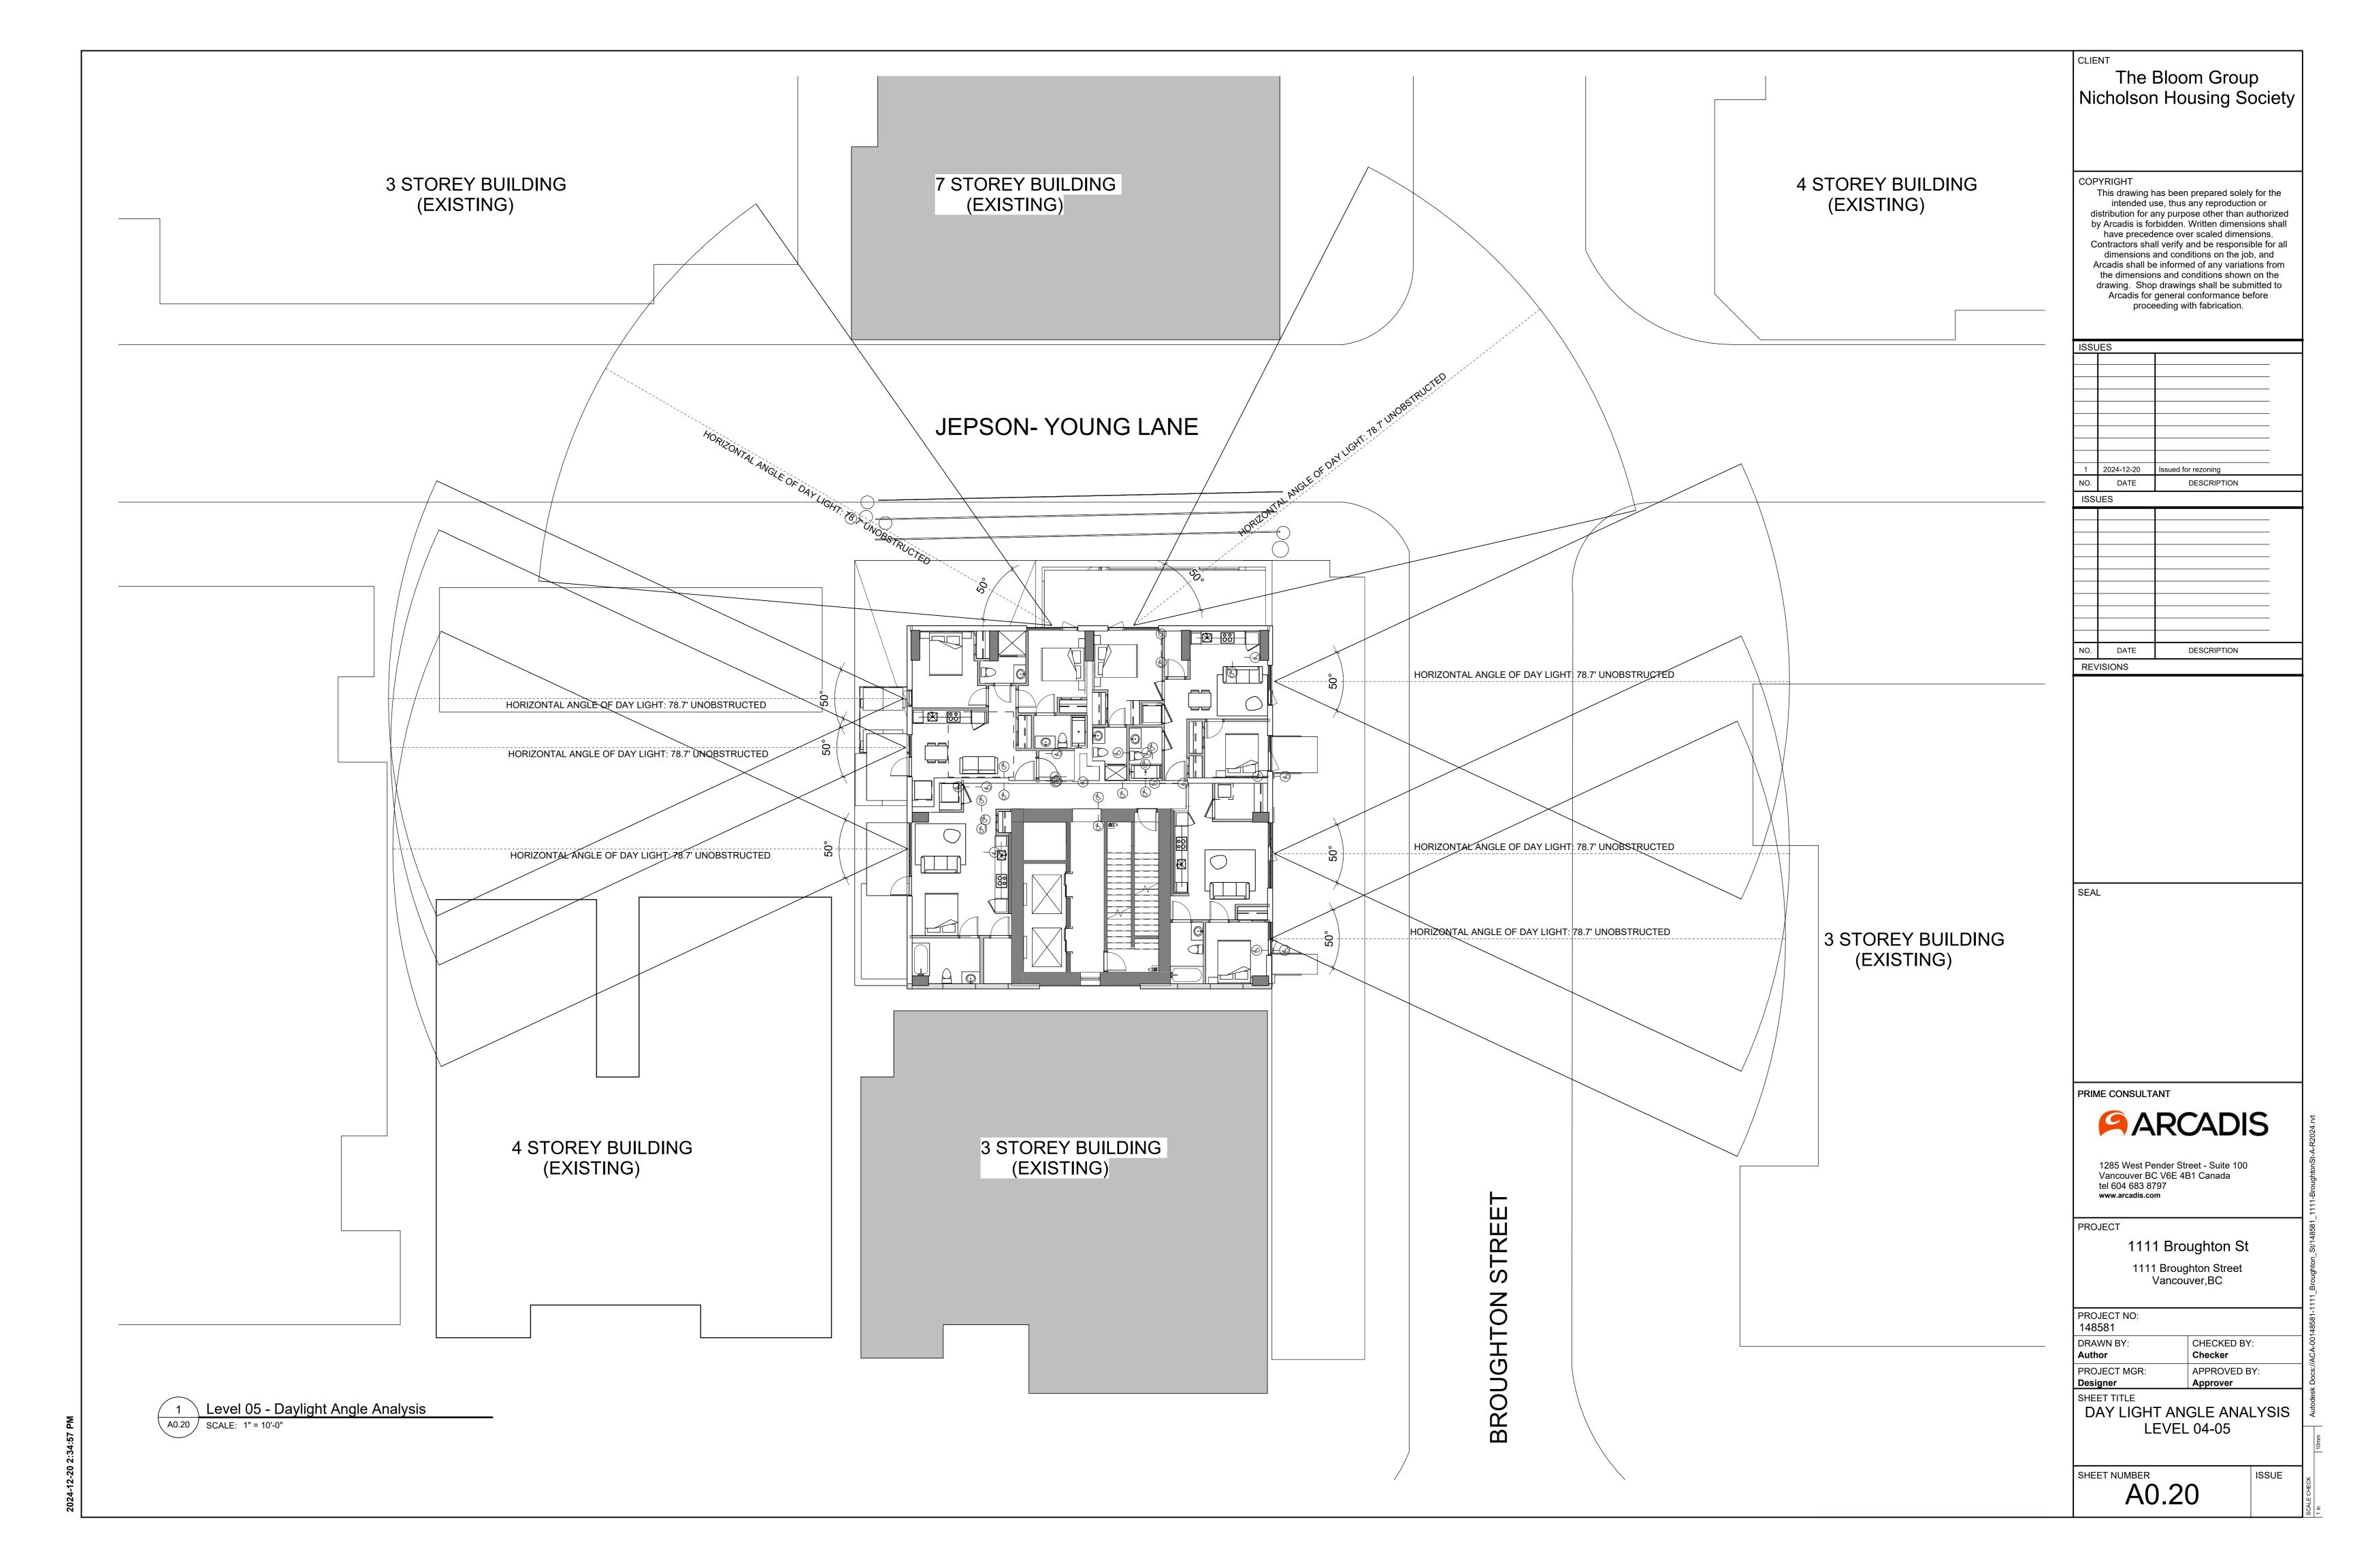
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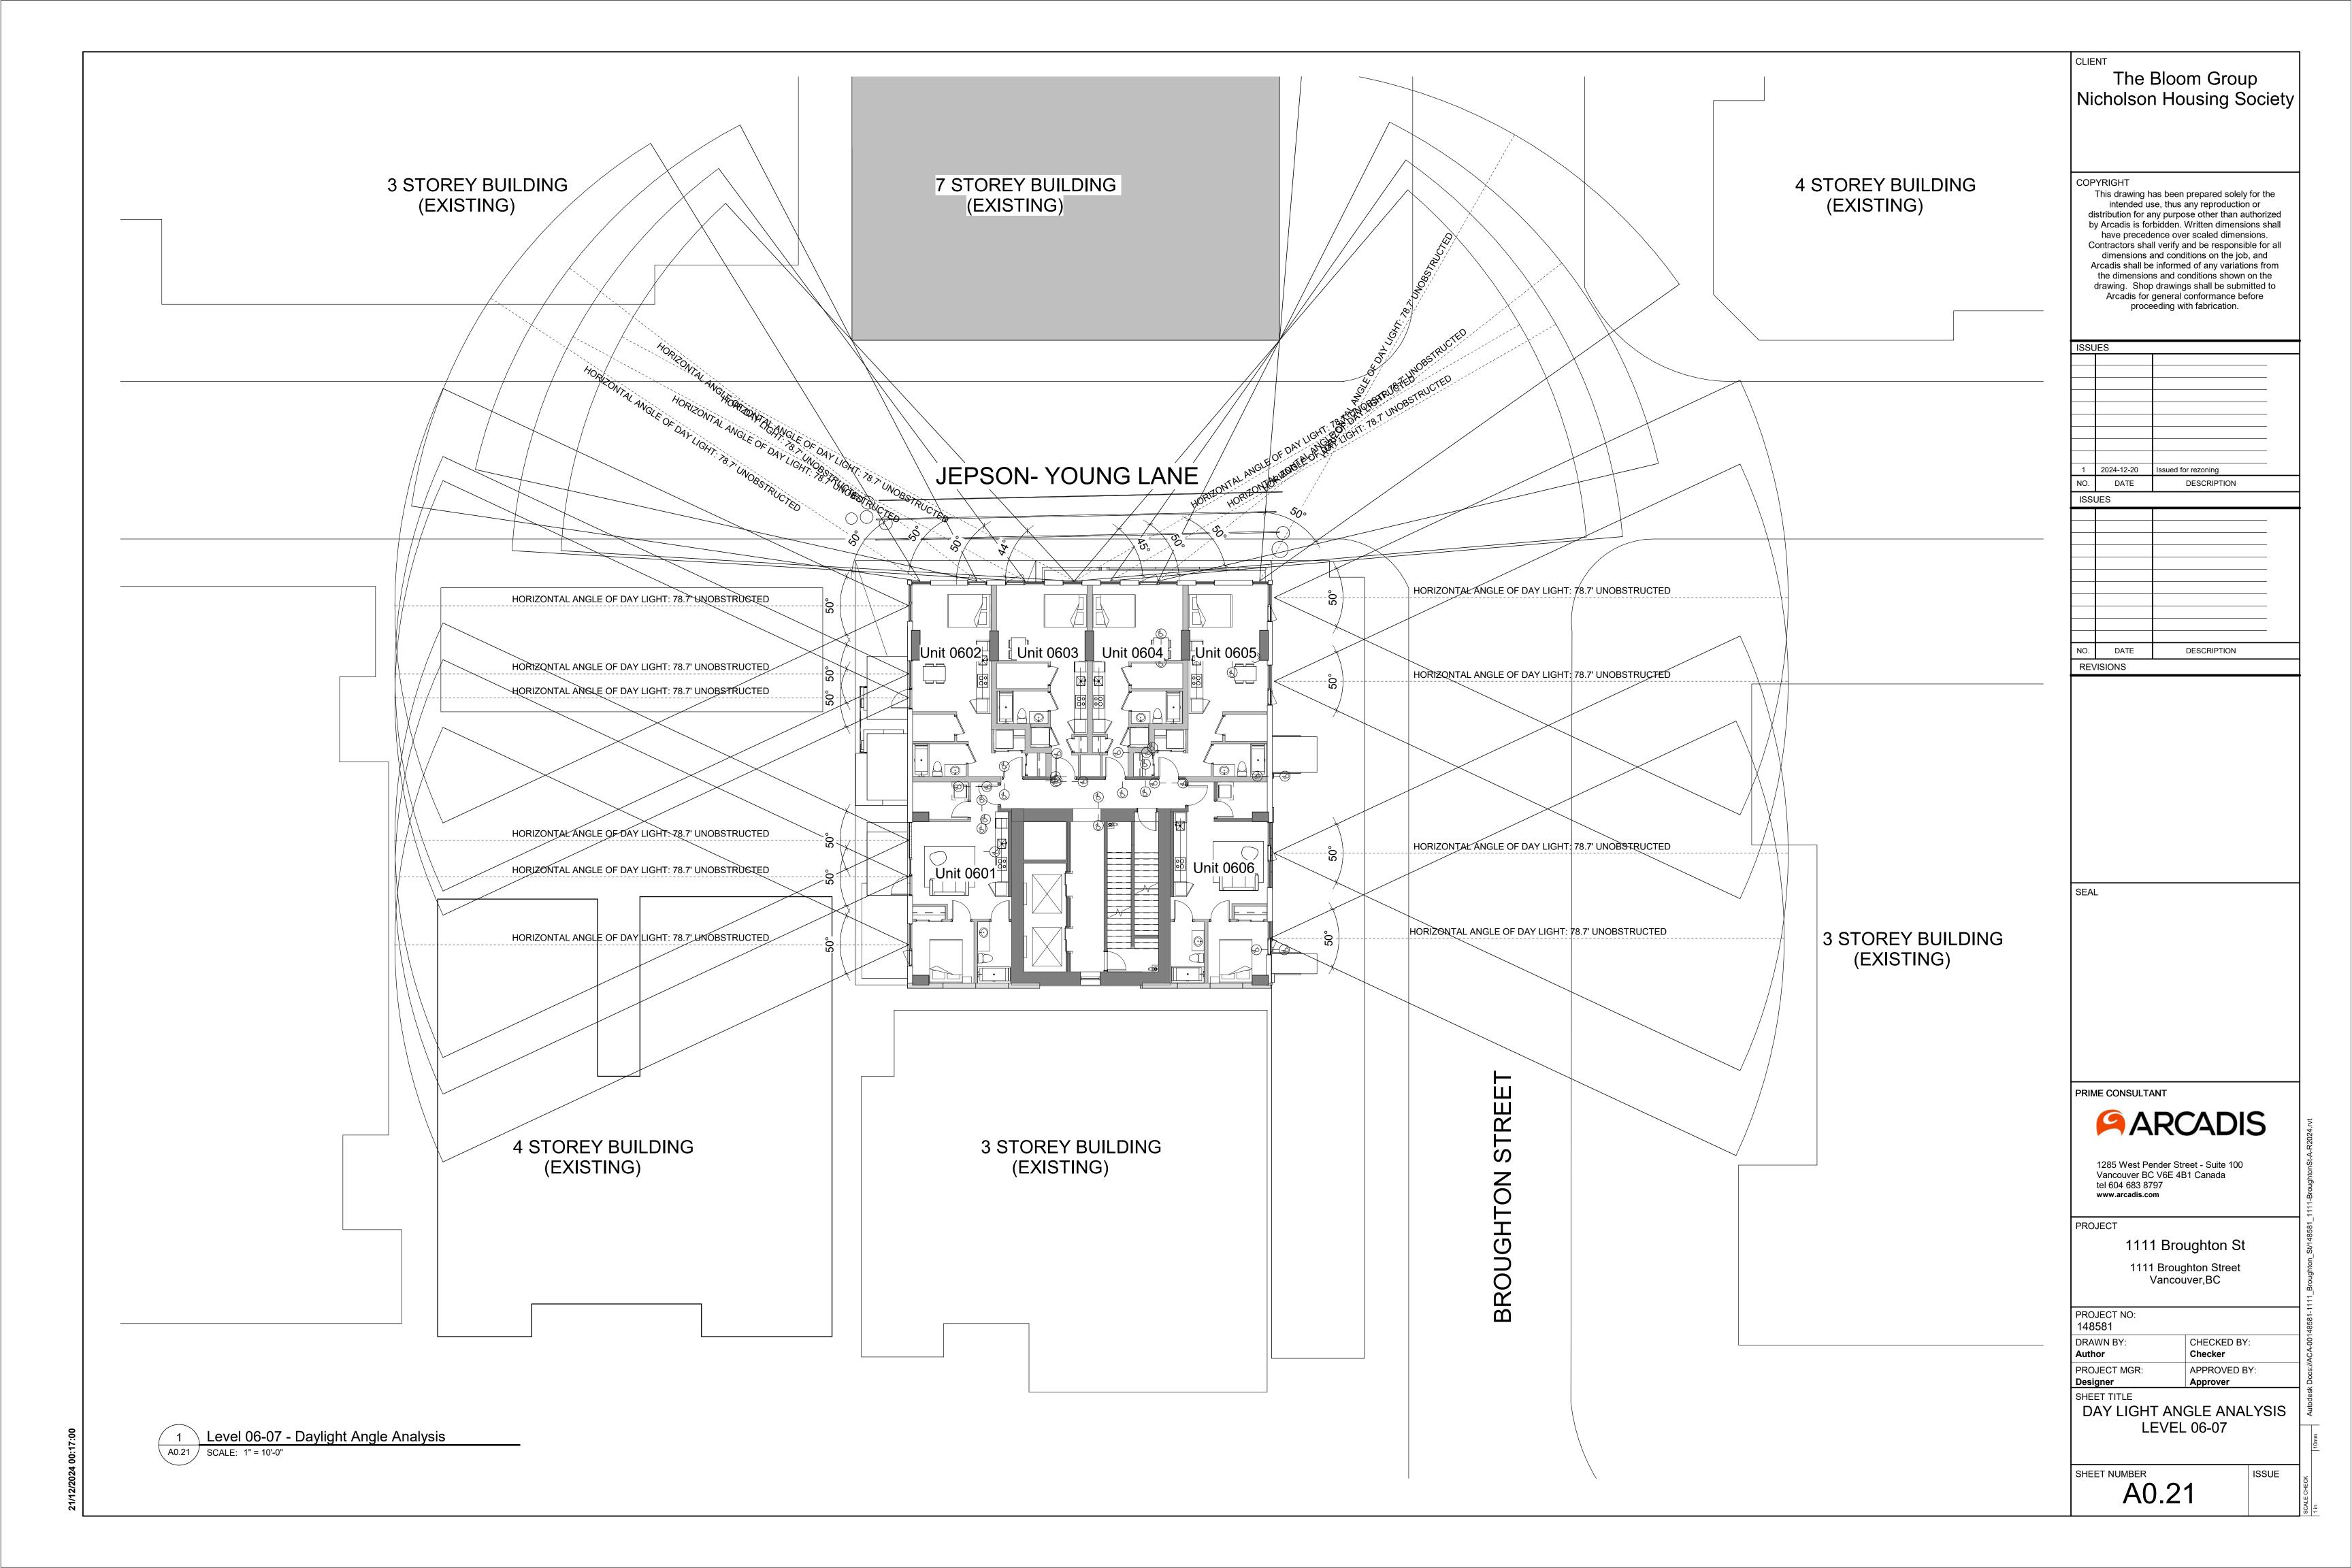
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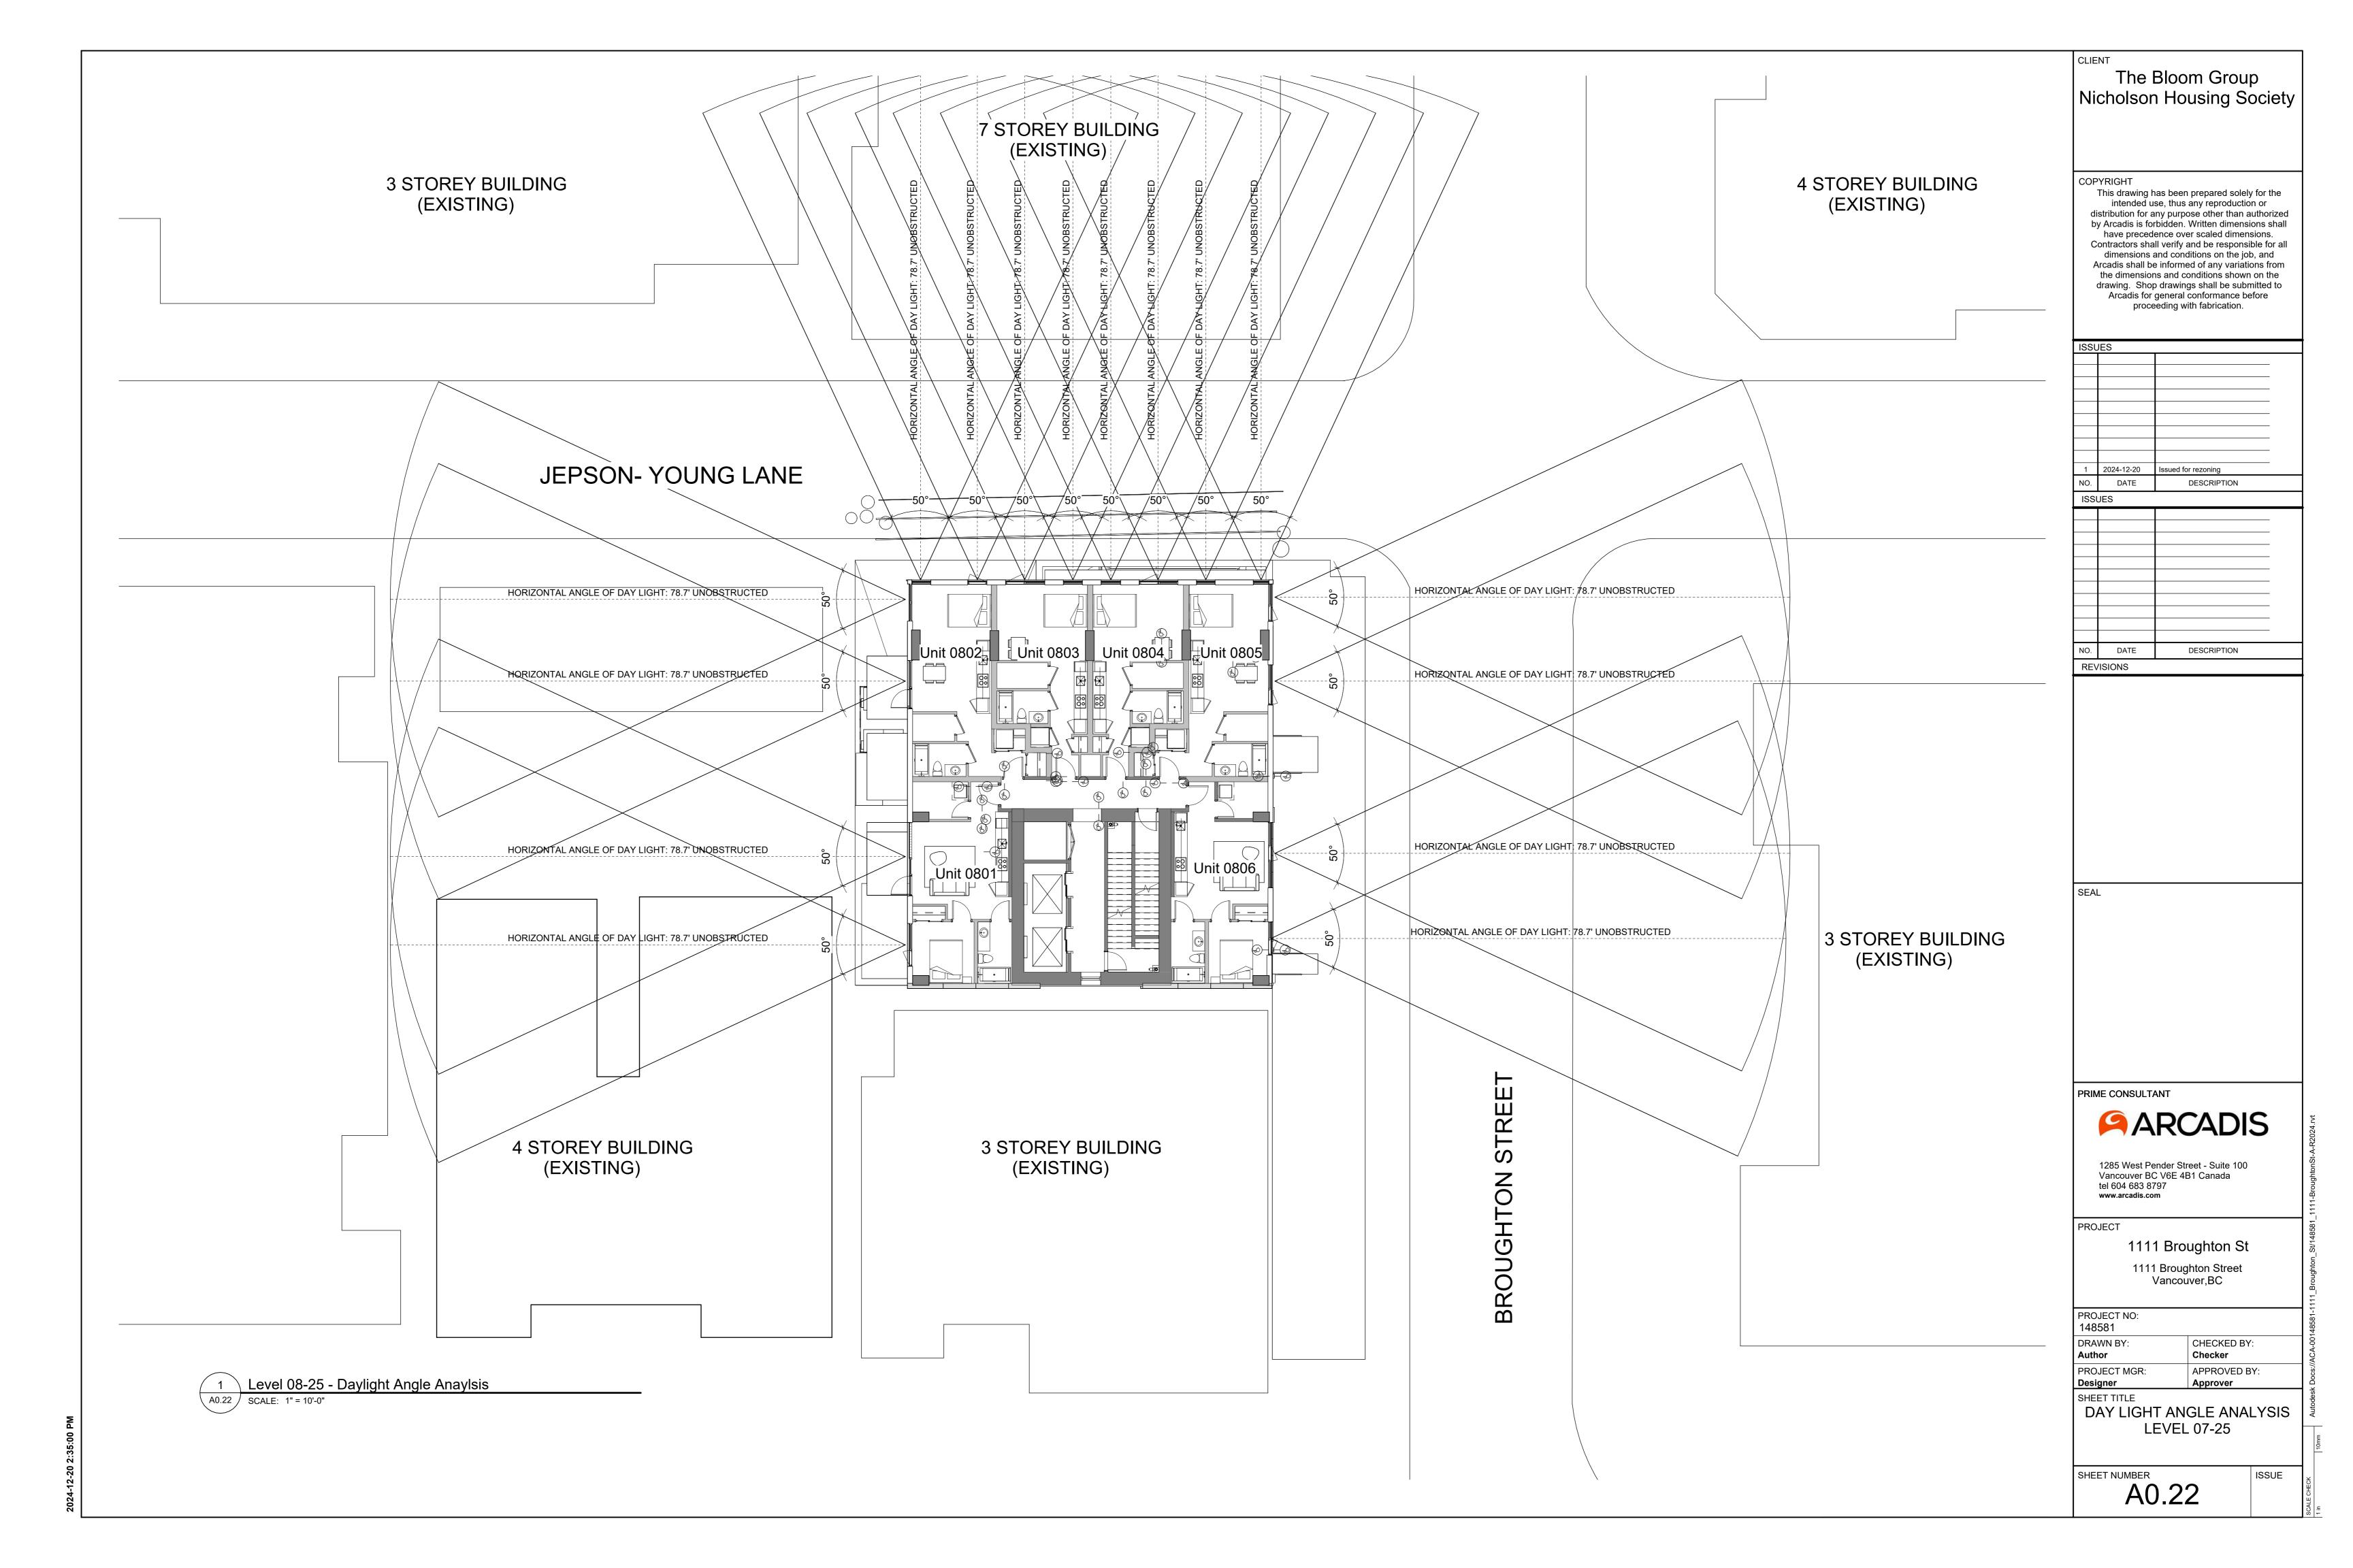
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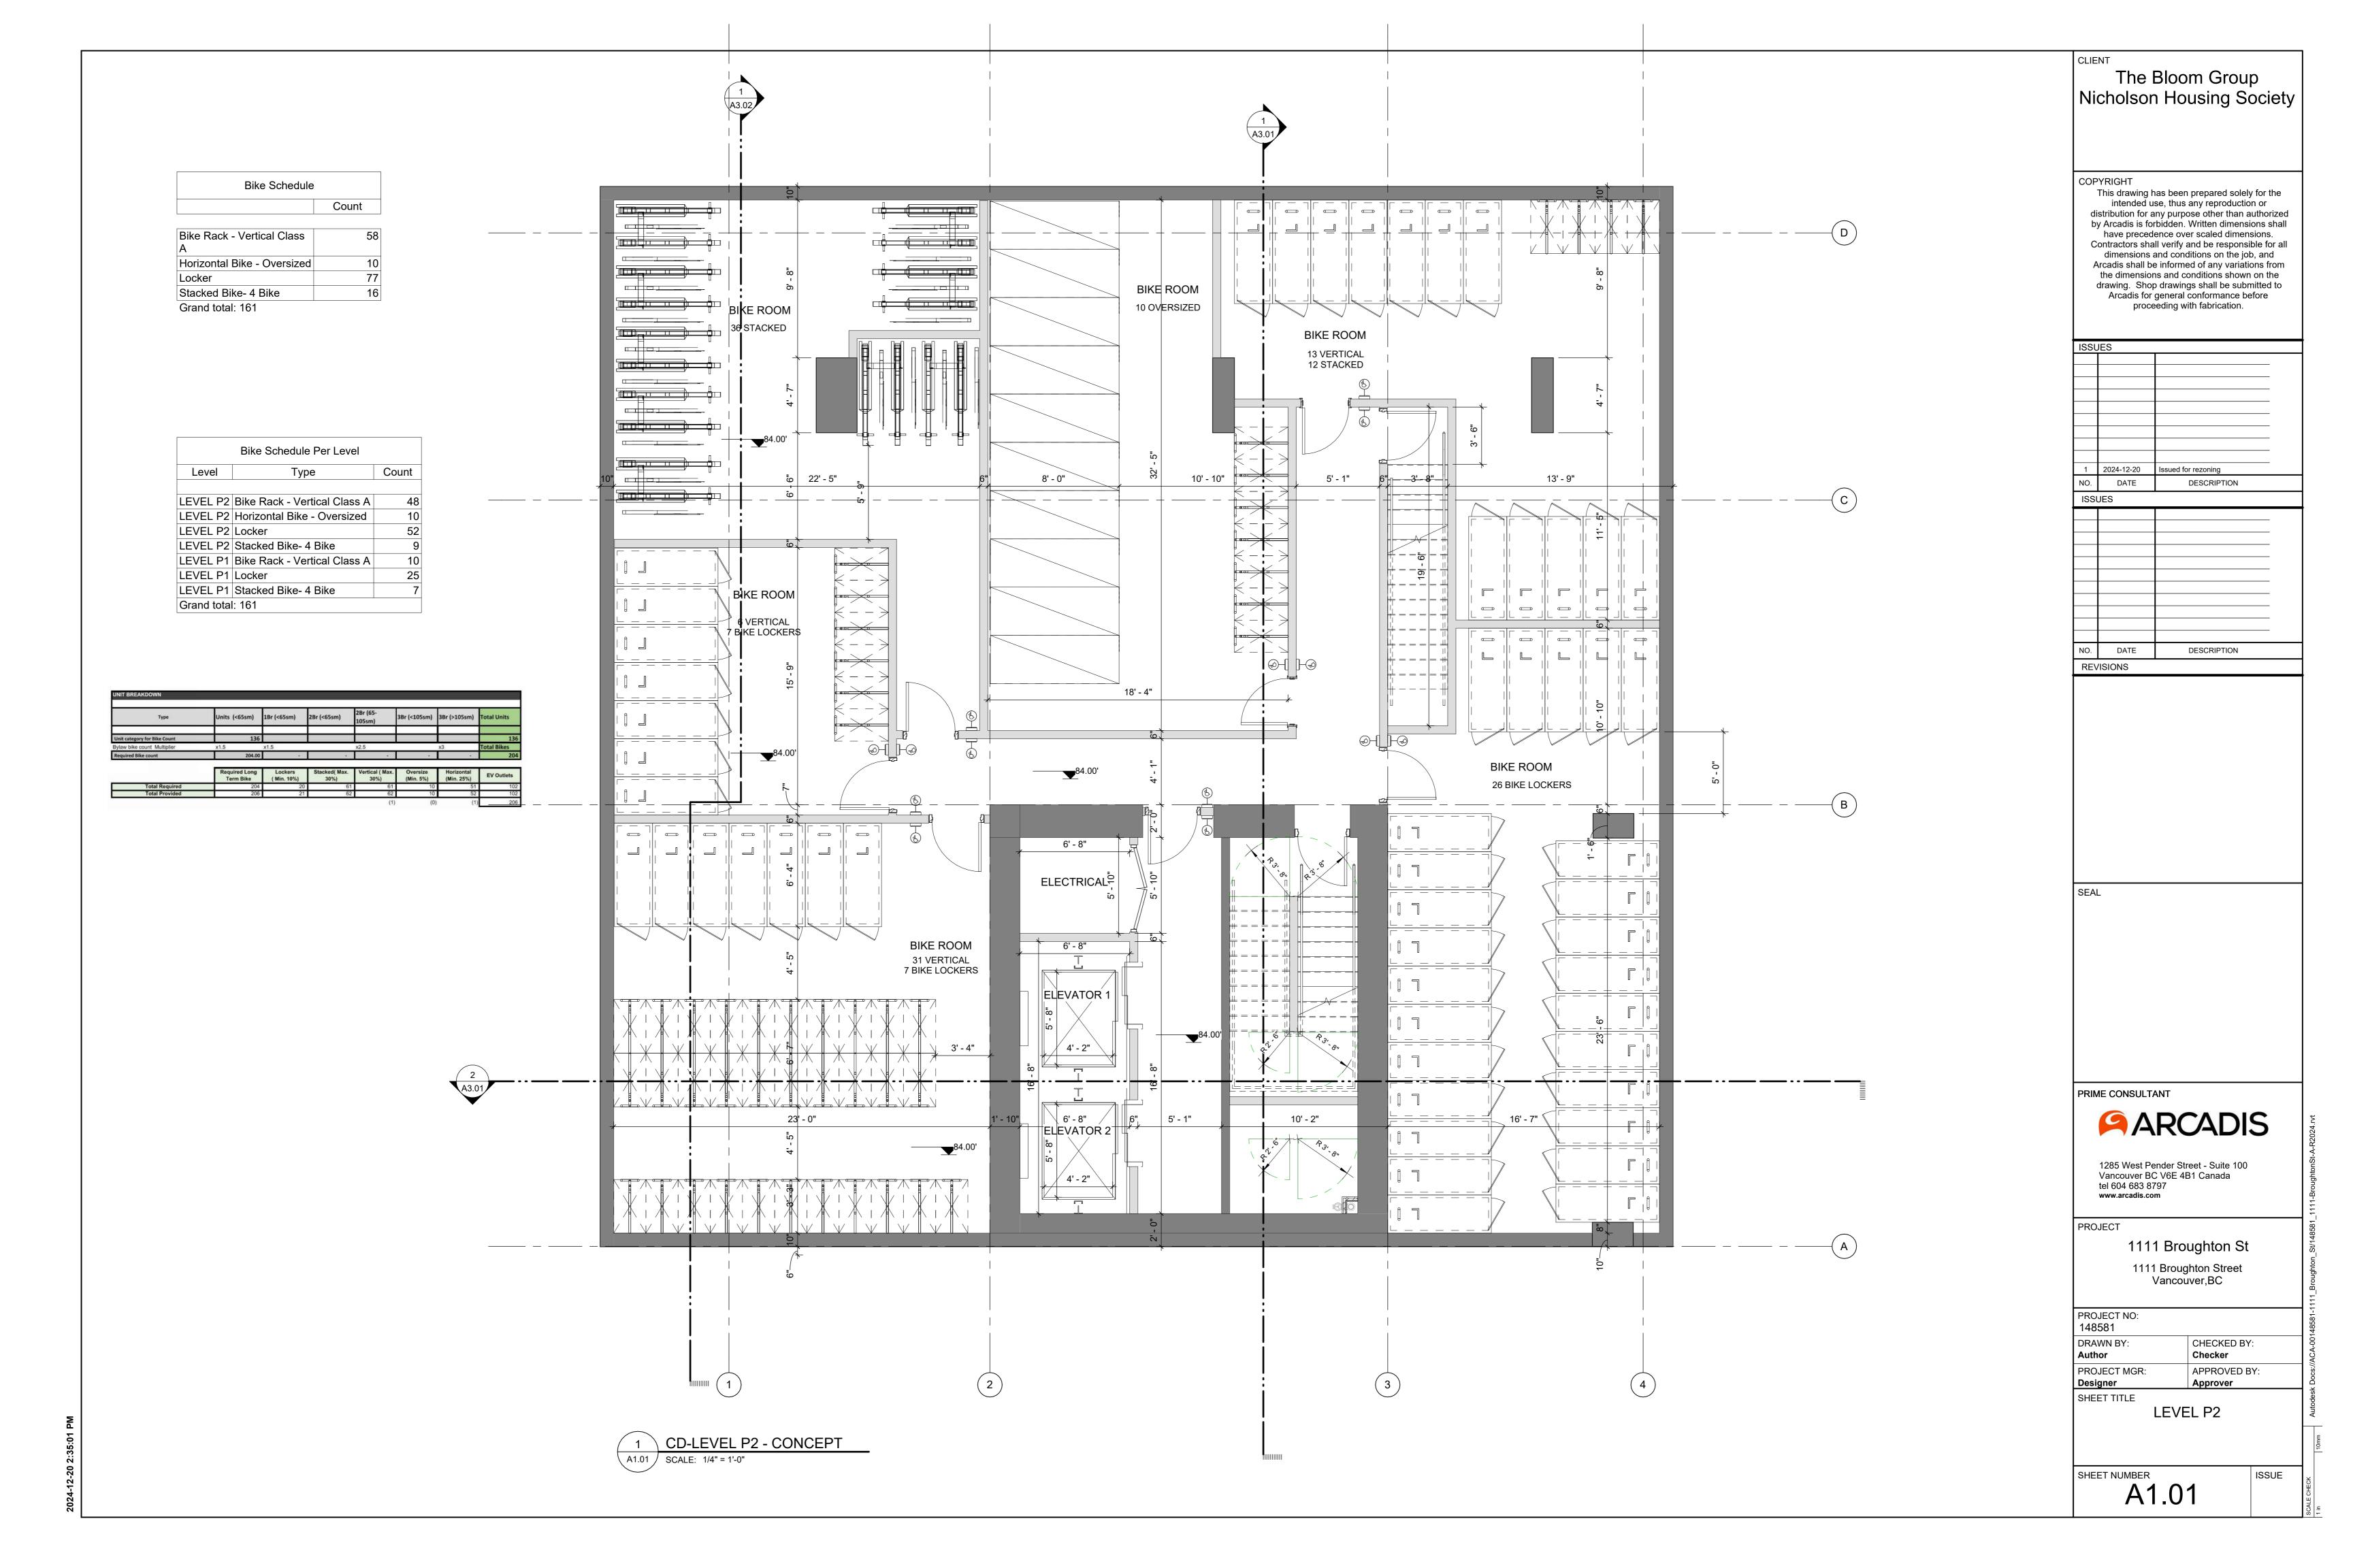
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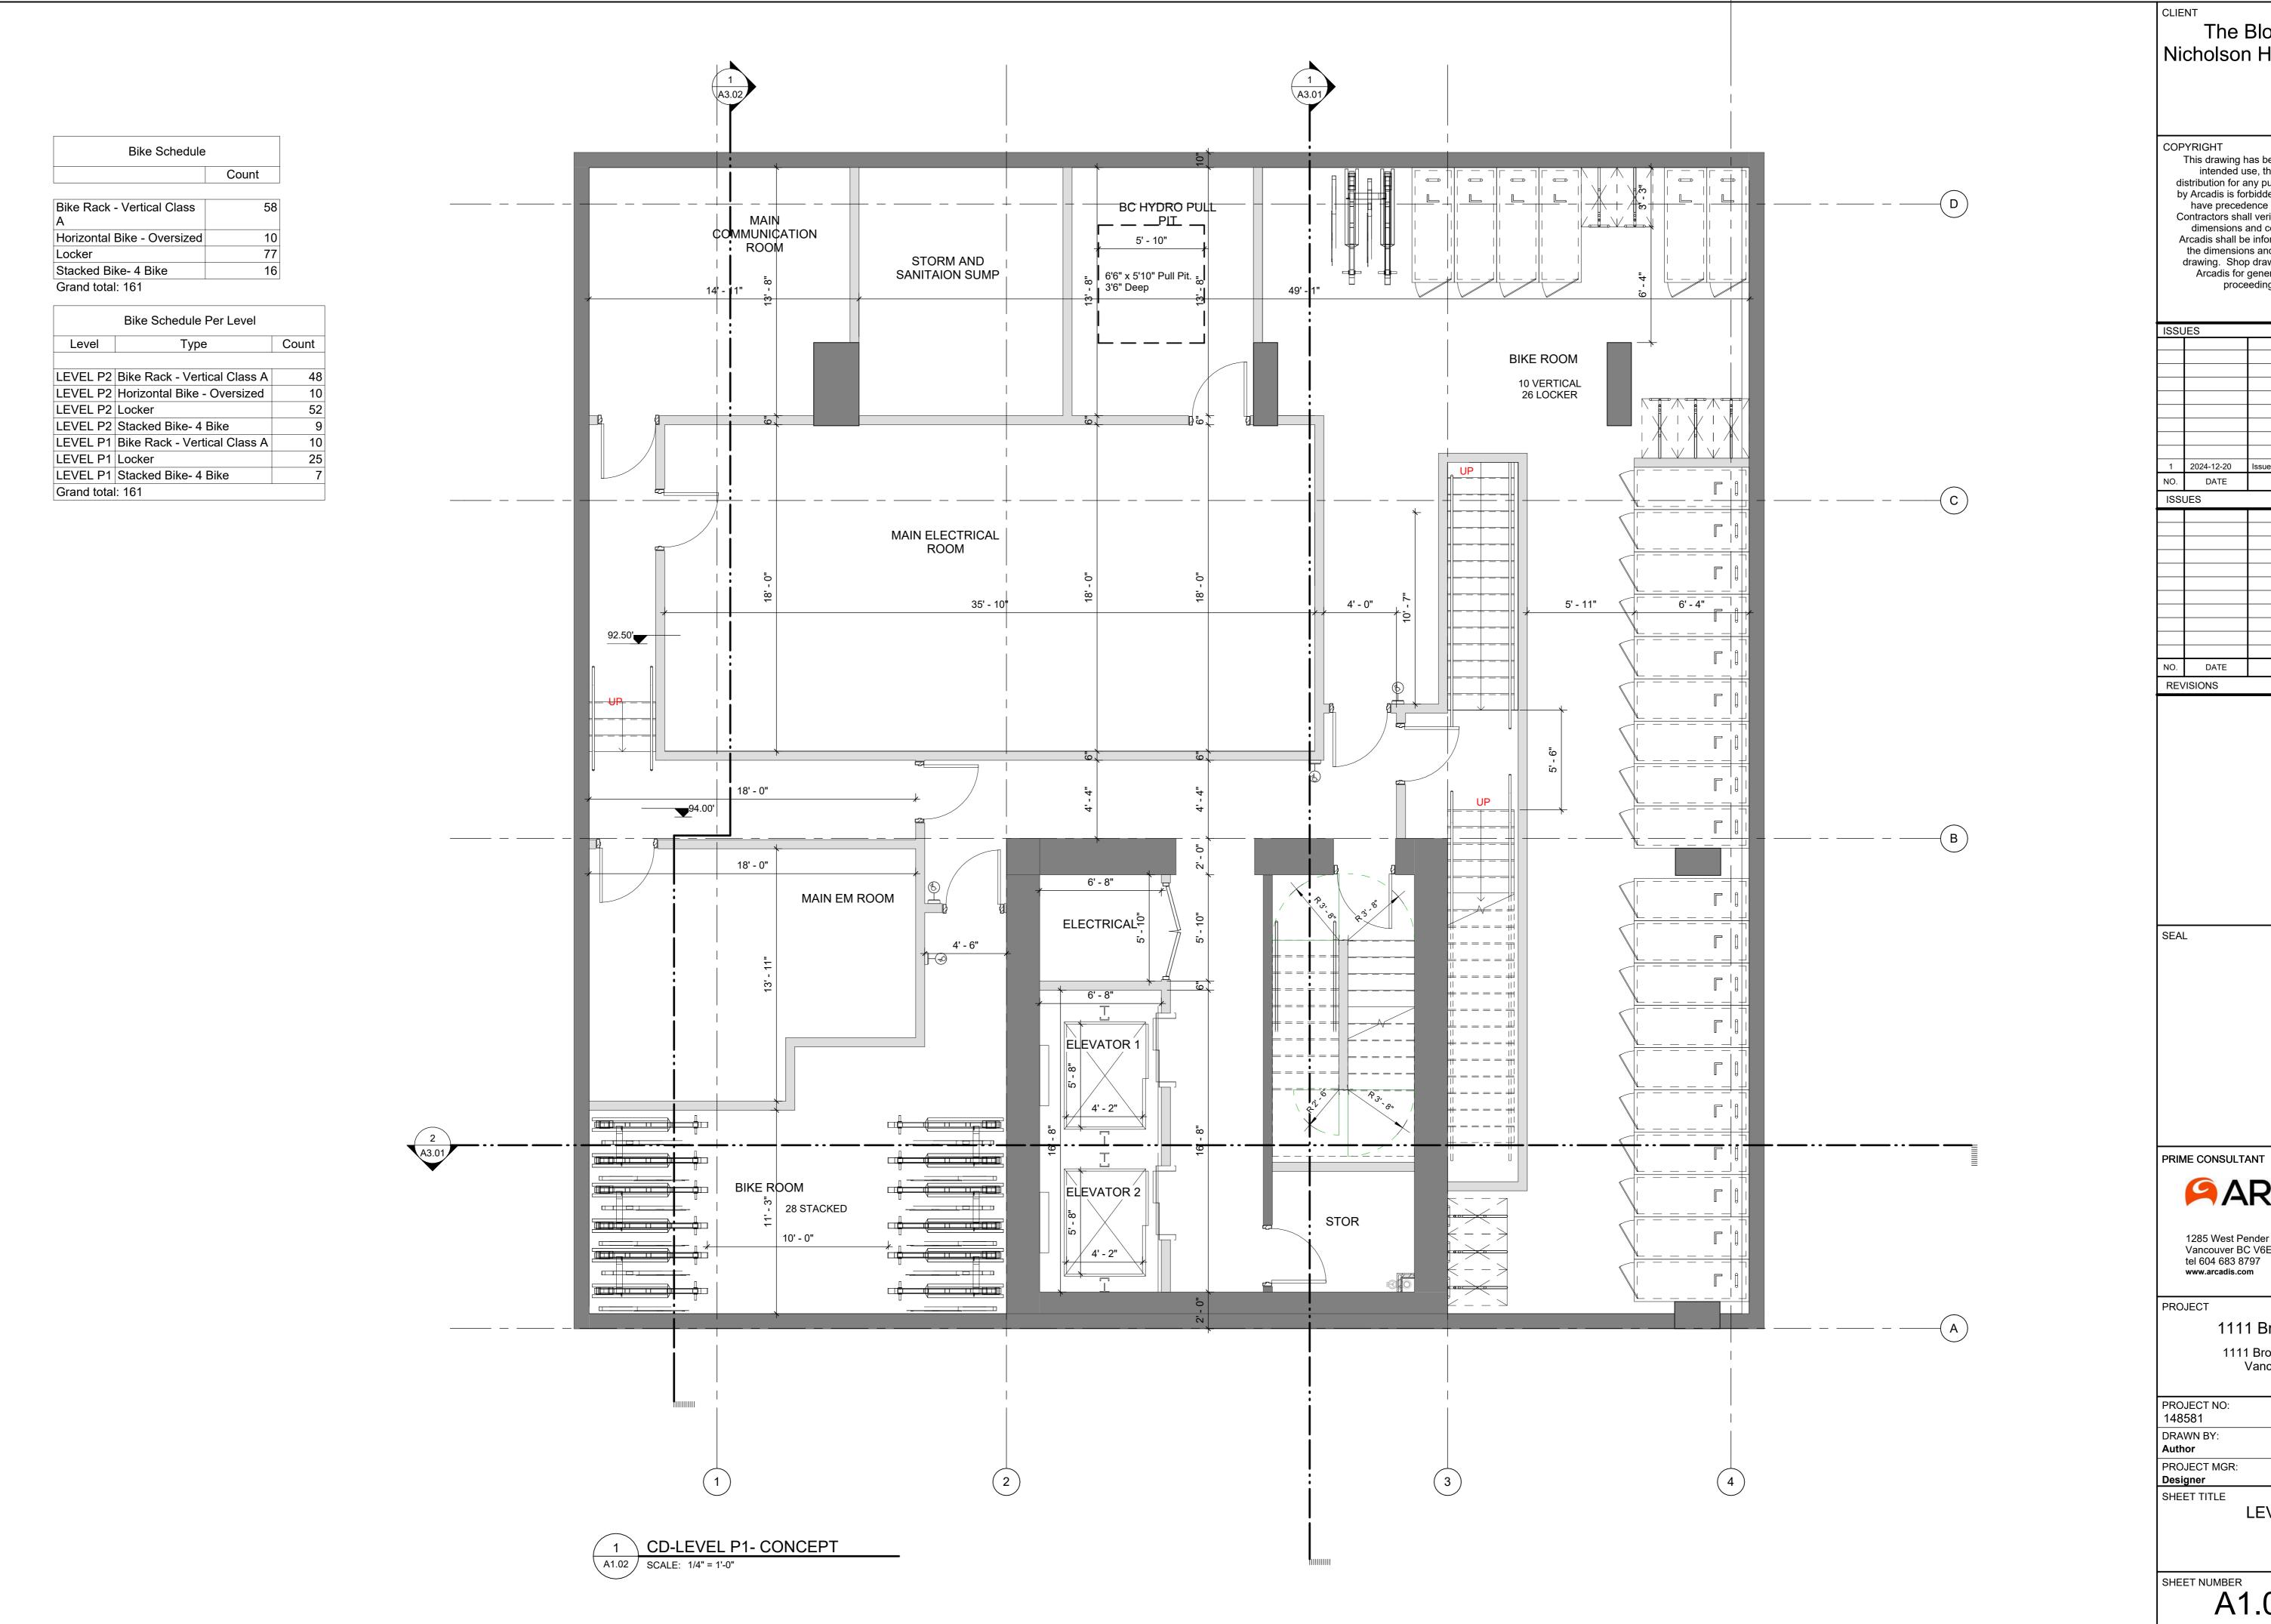












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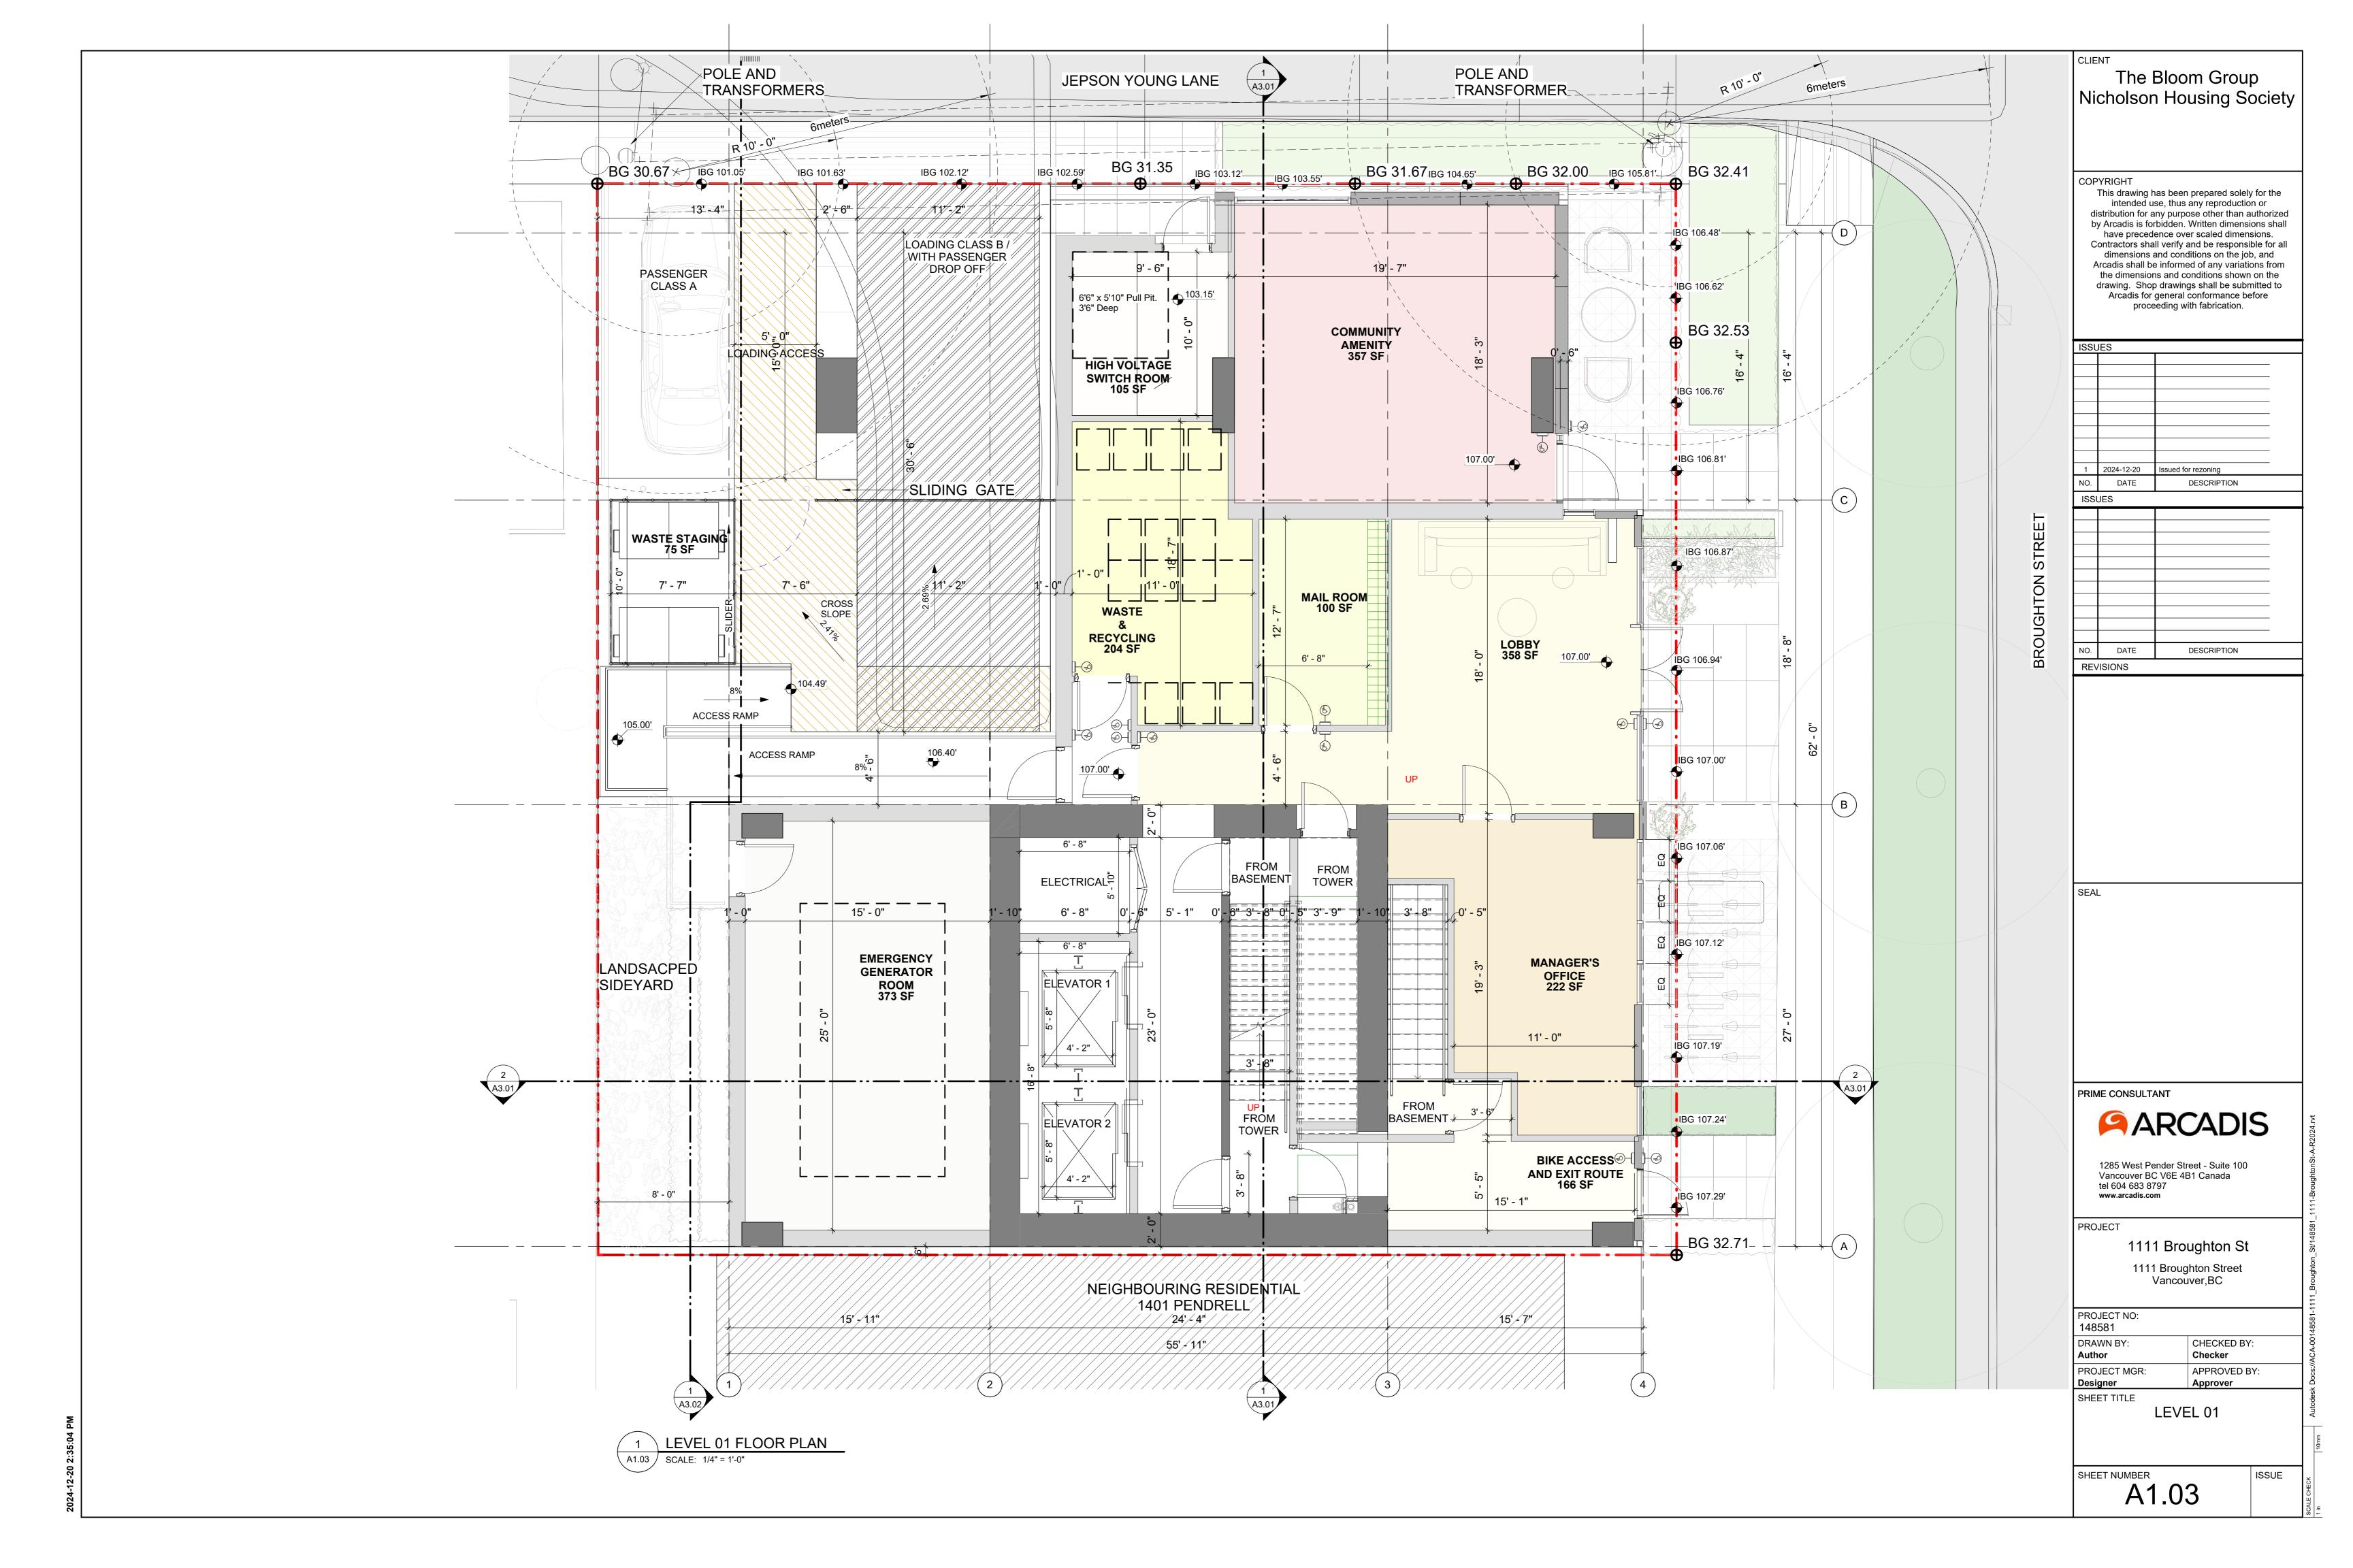
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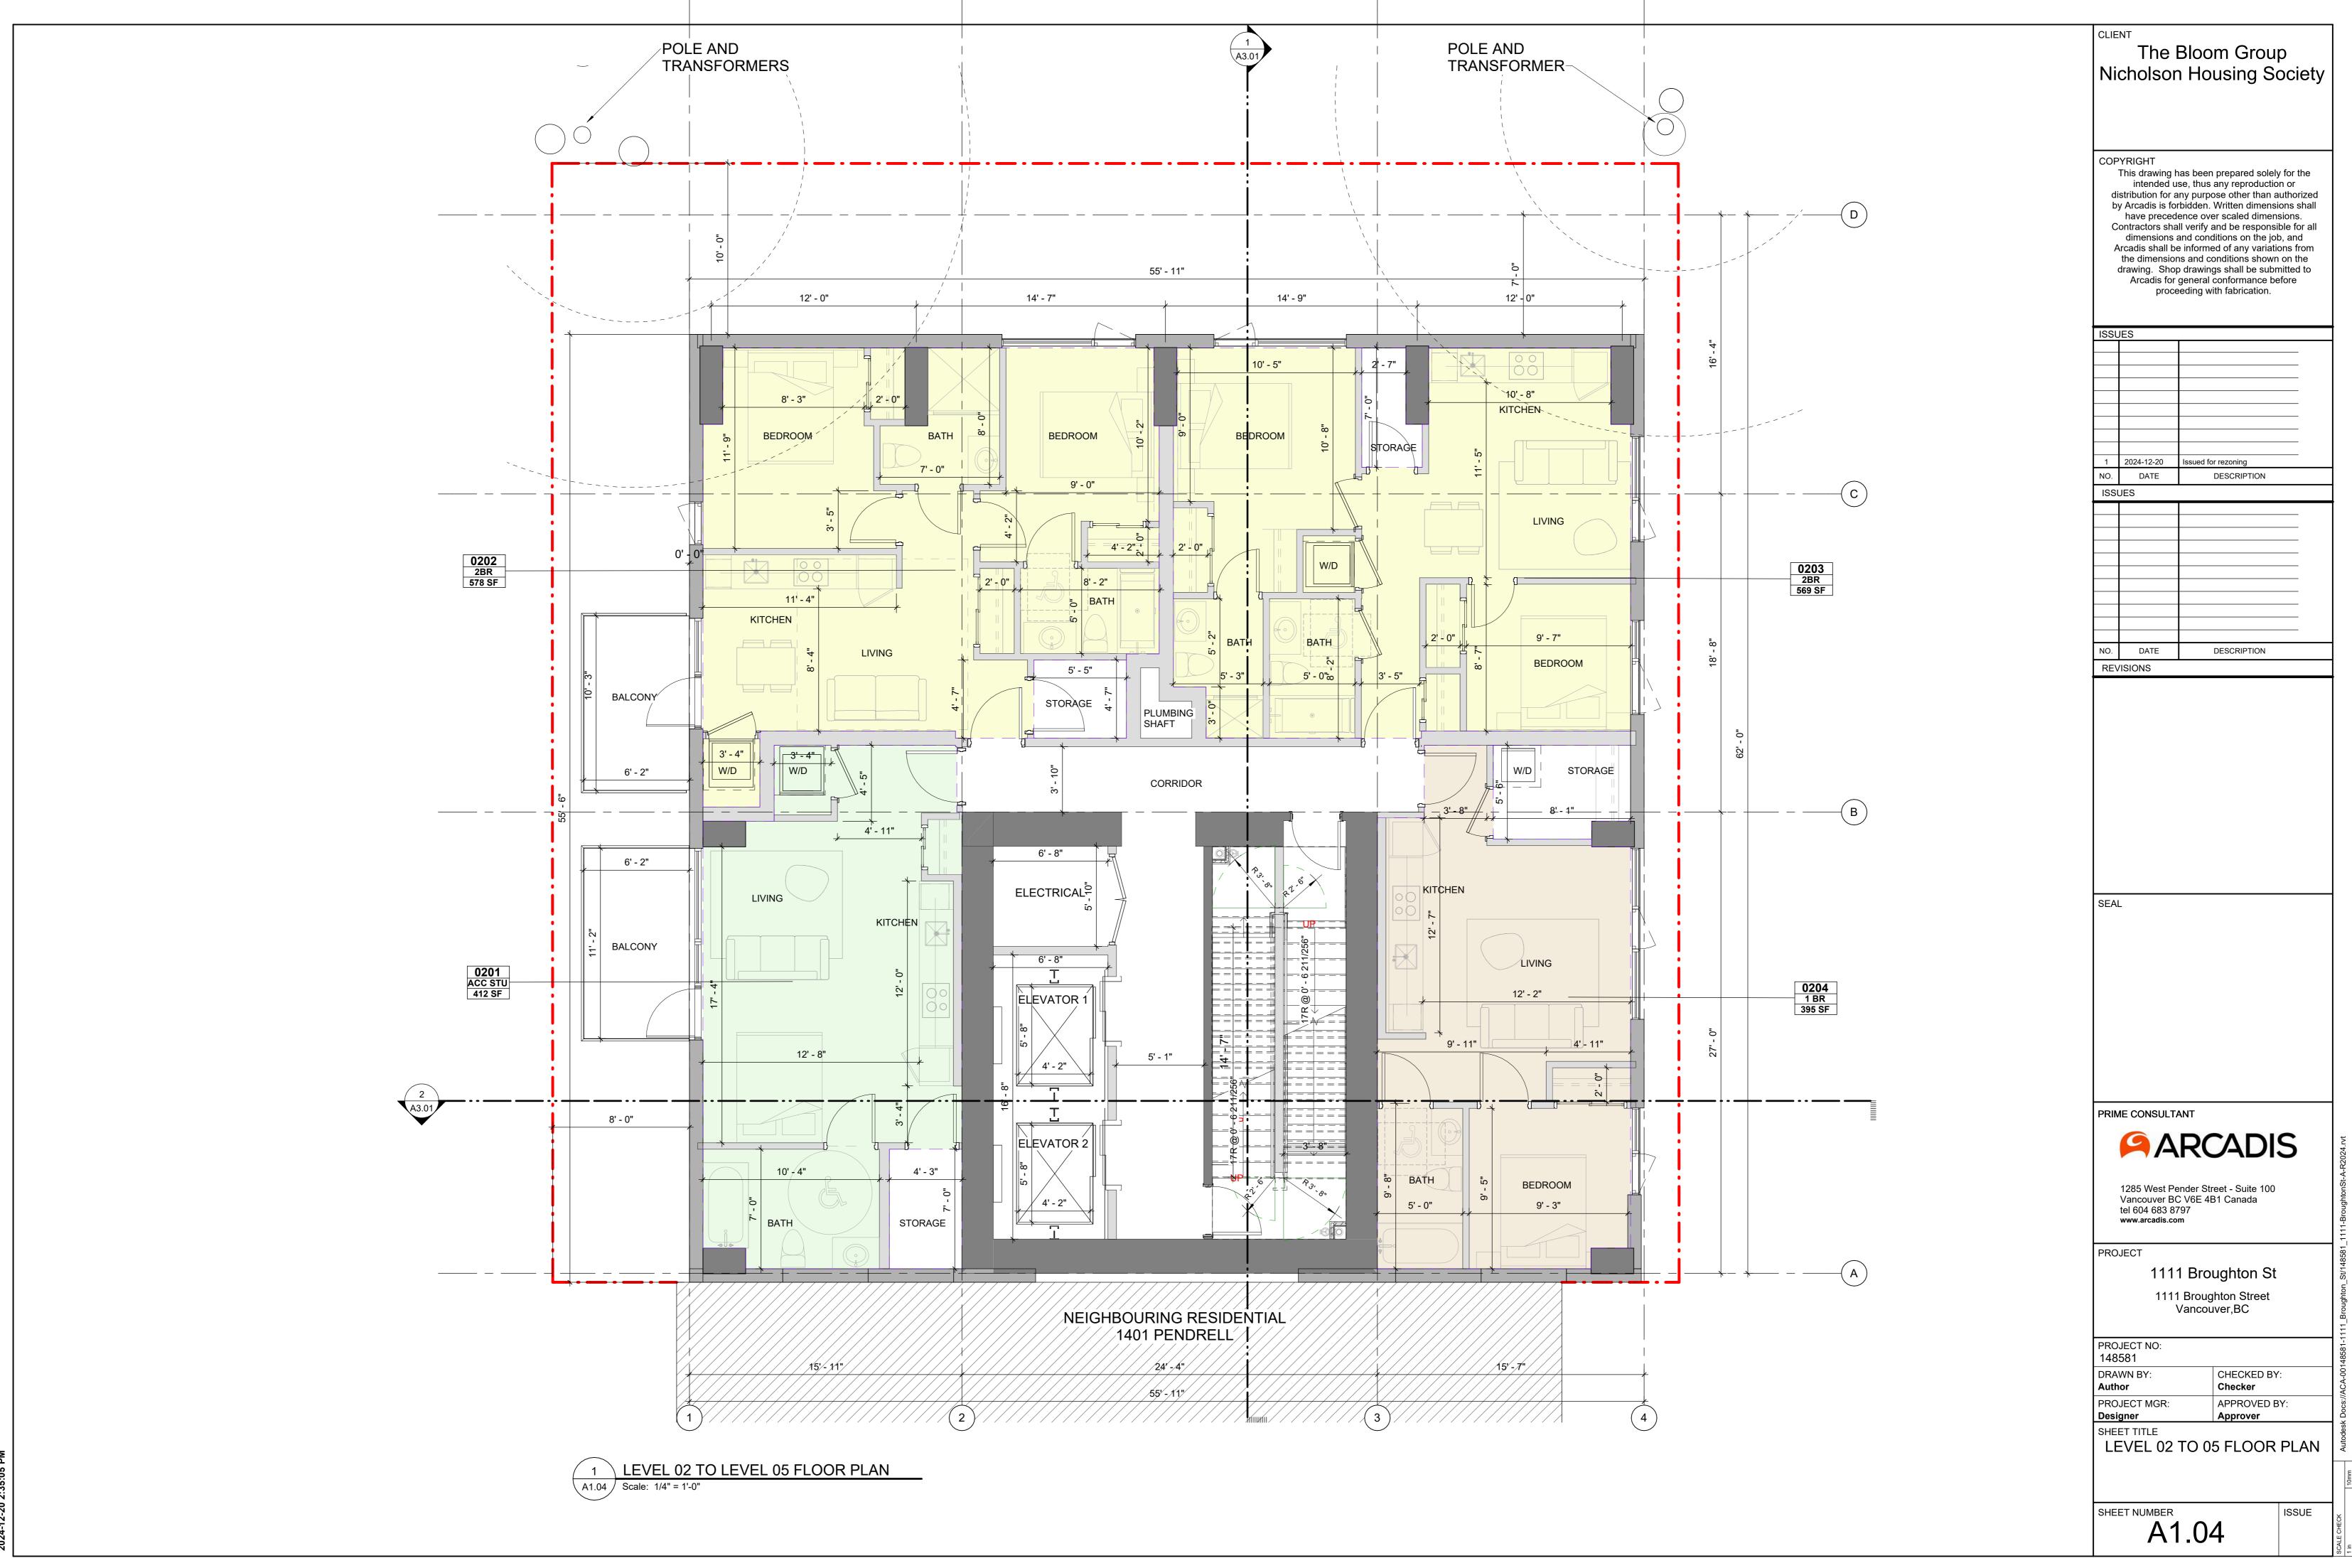
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LEVEL P1


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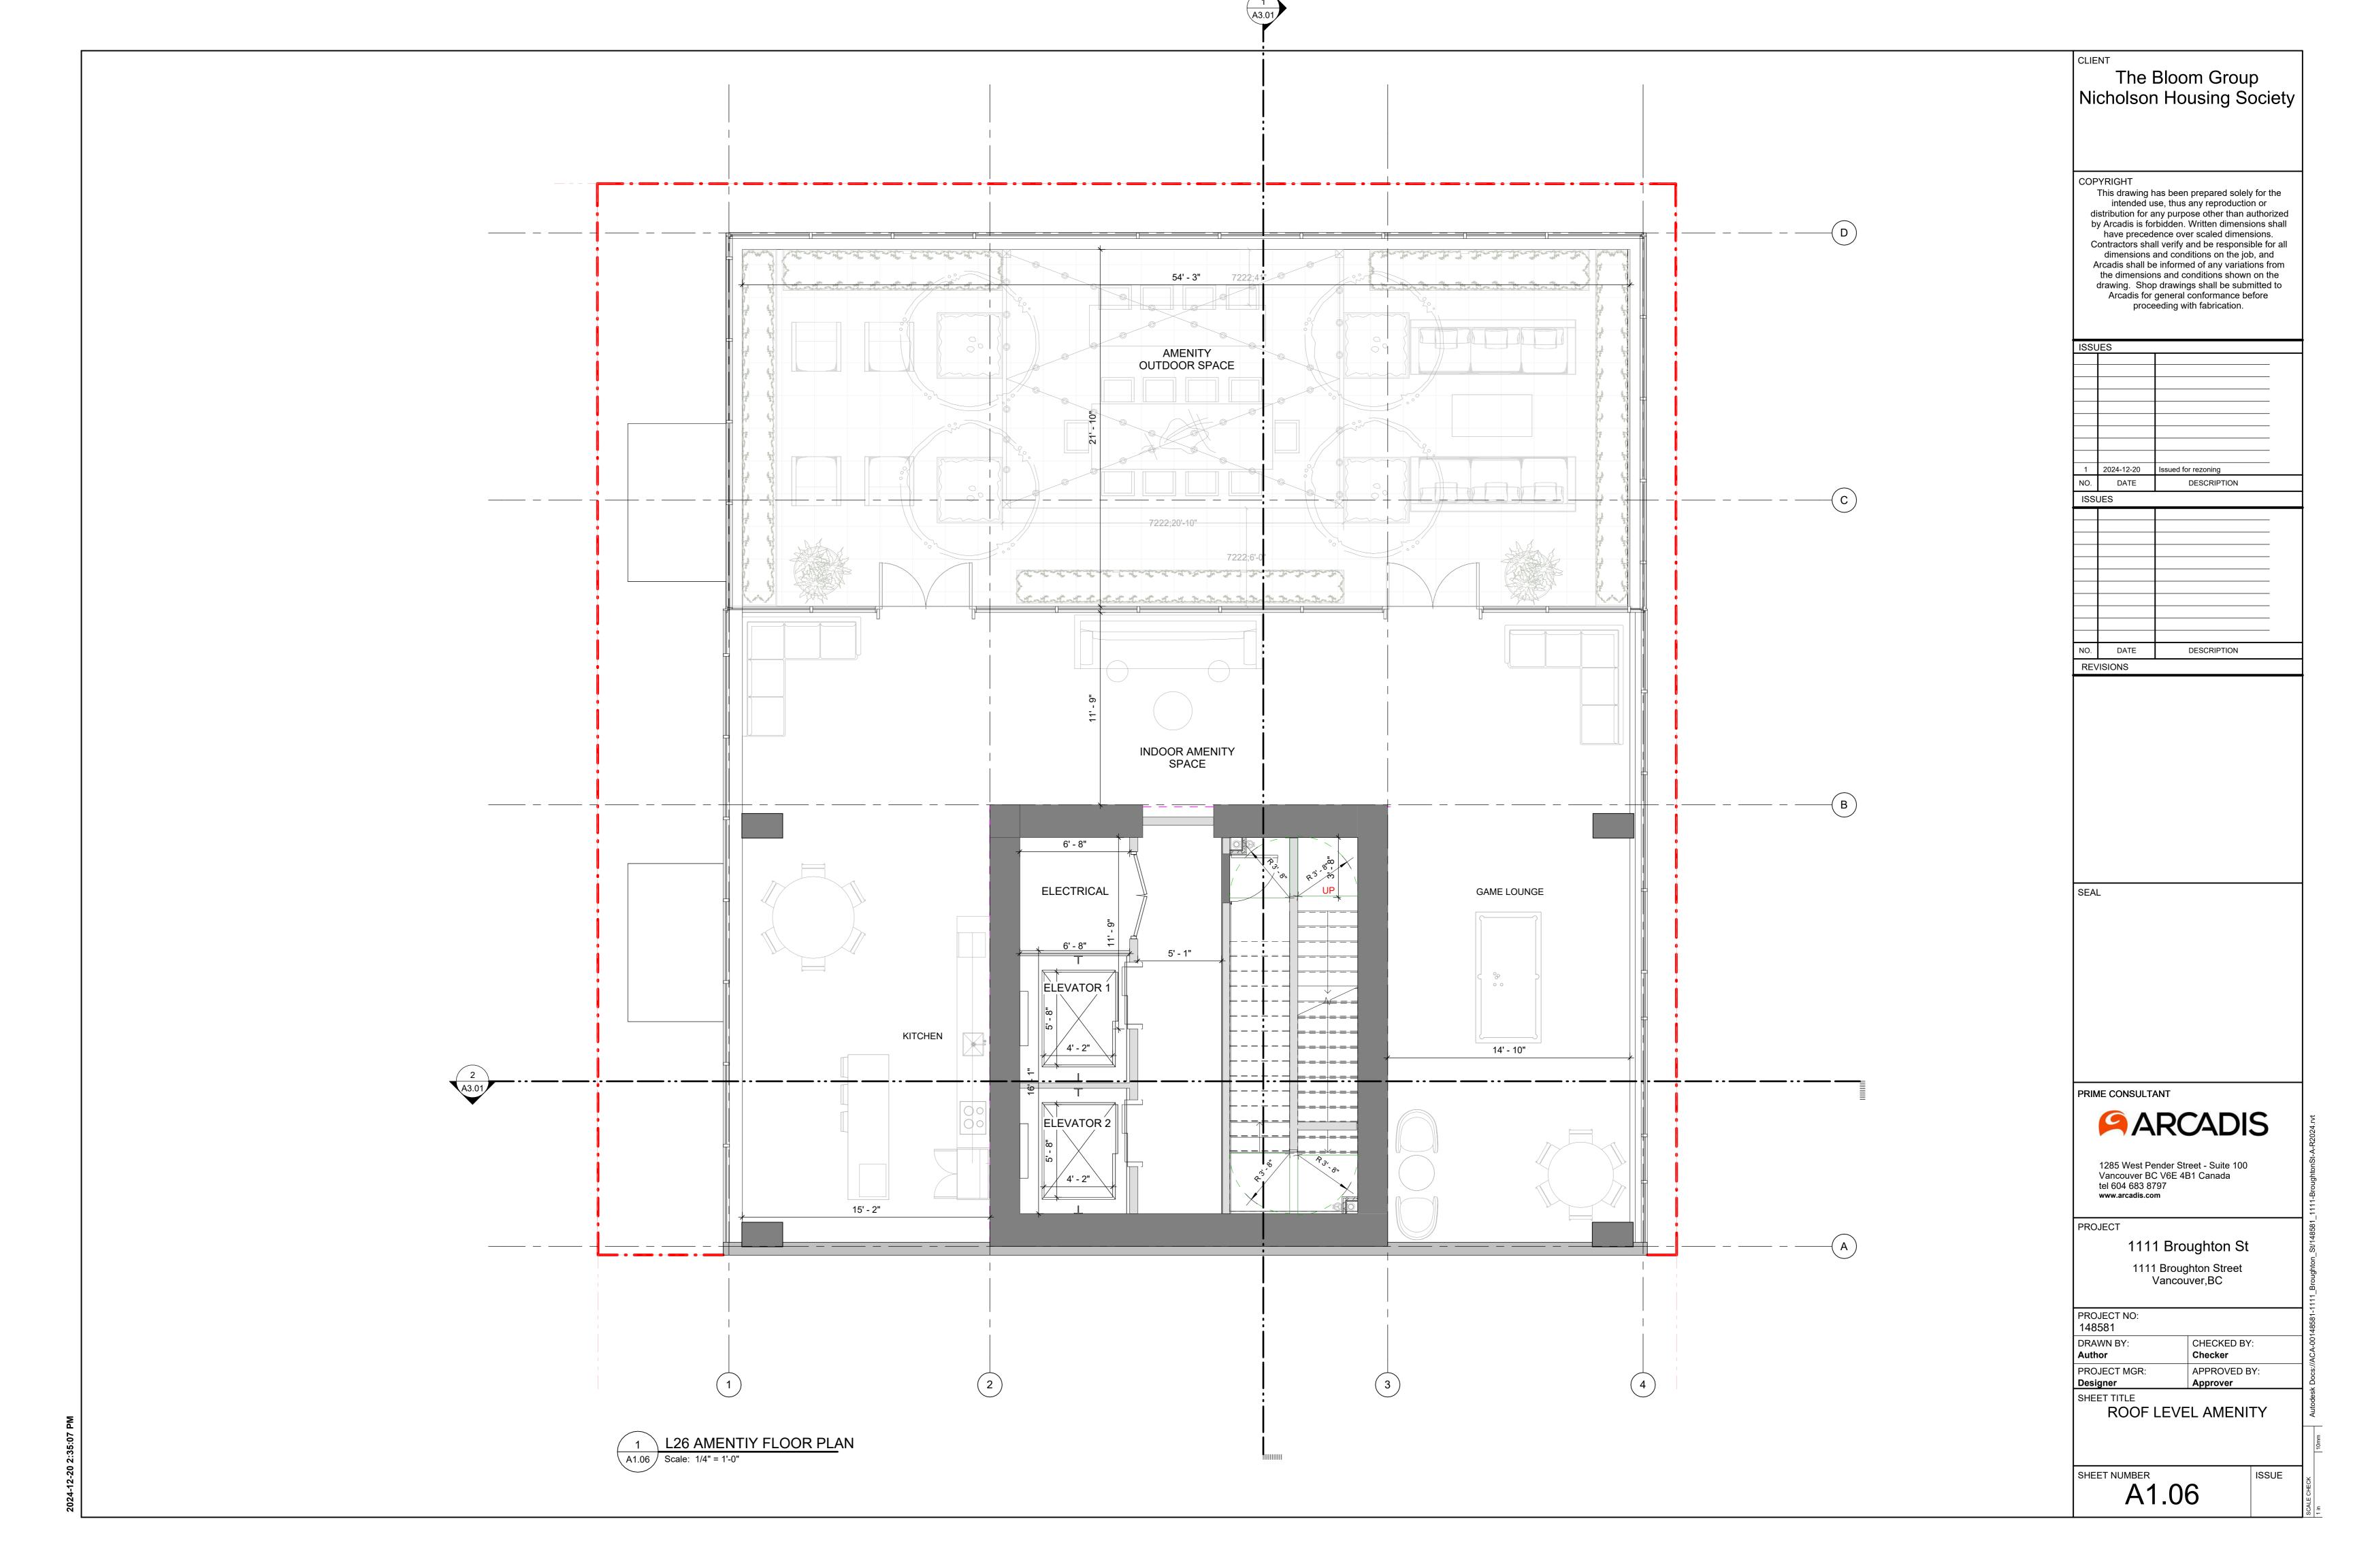
A1.02







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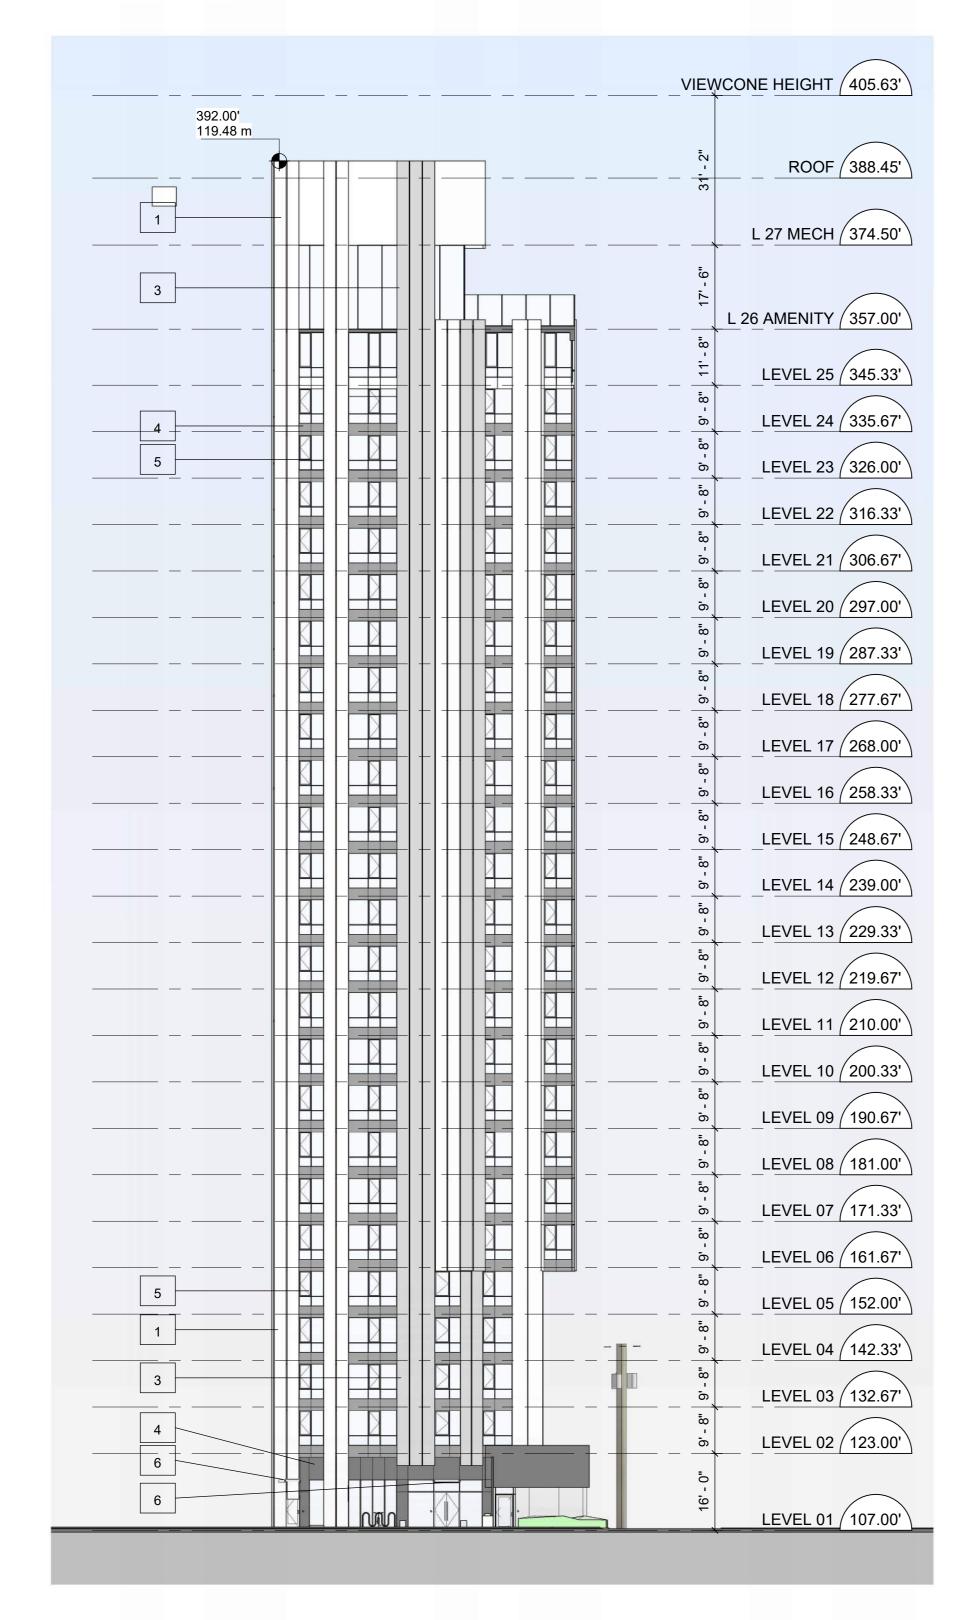





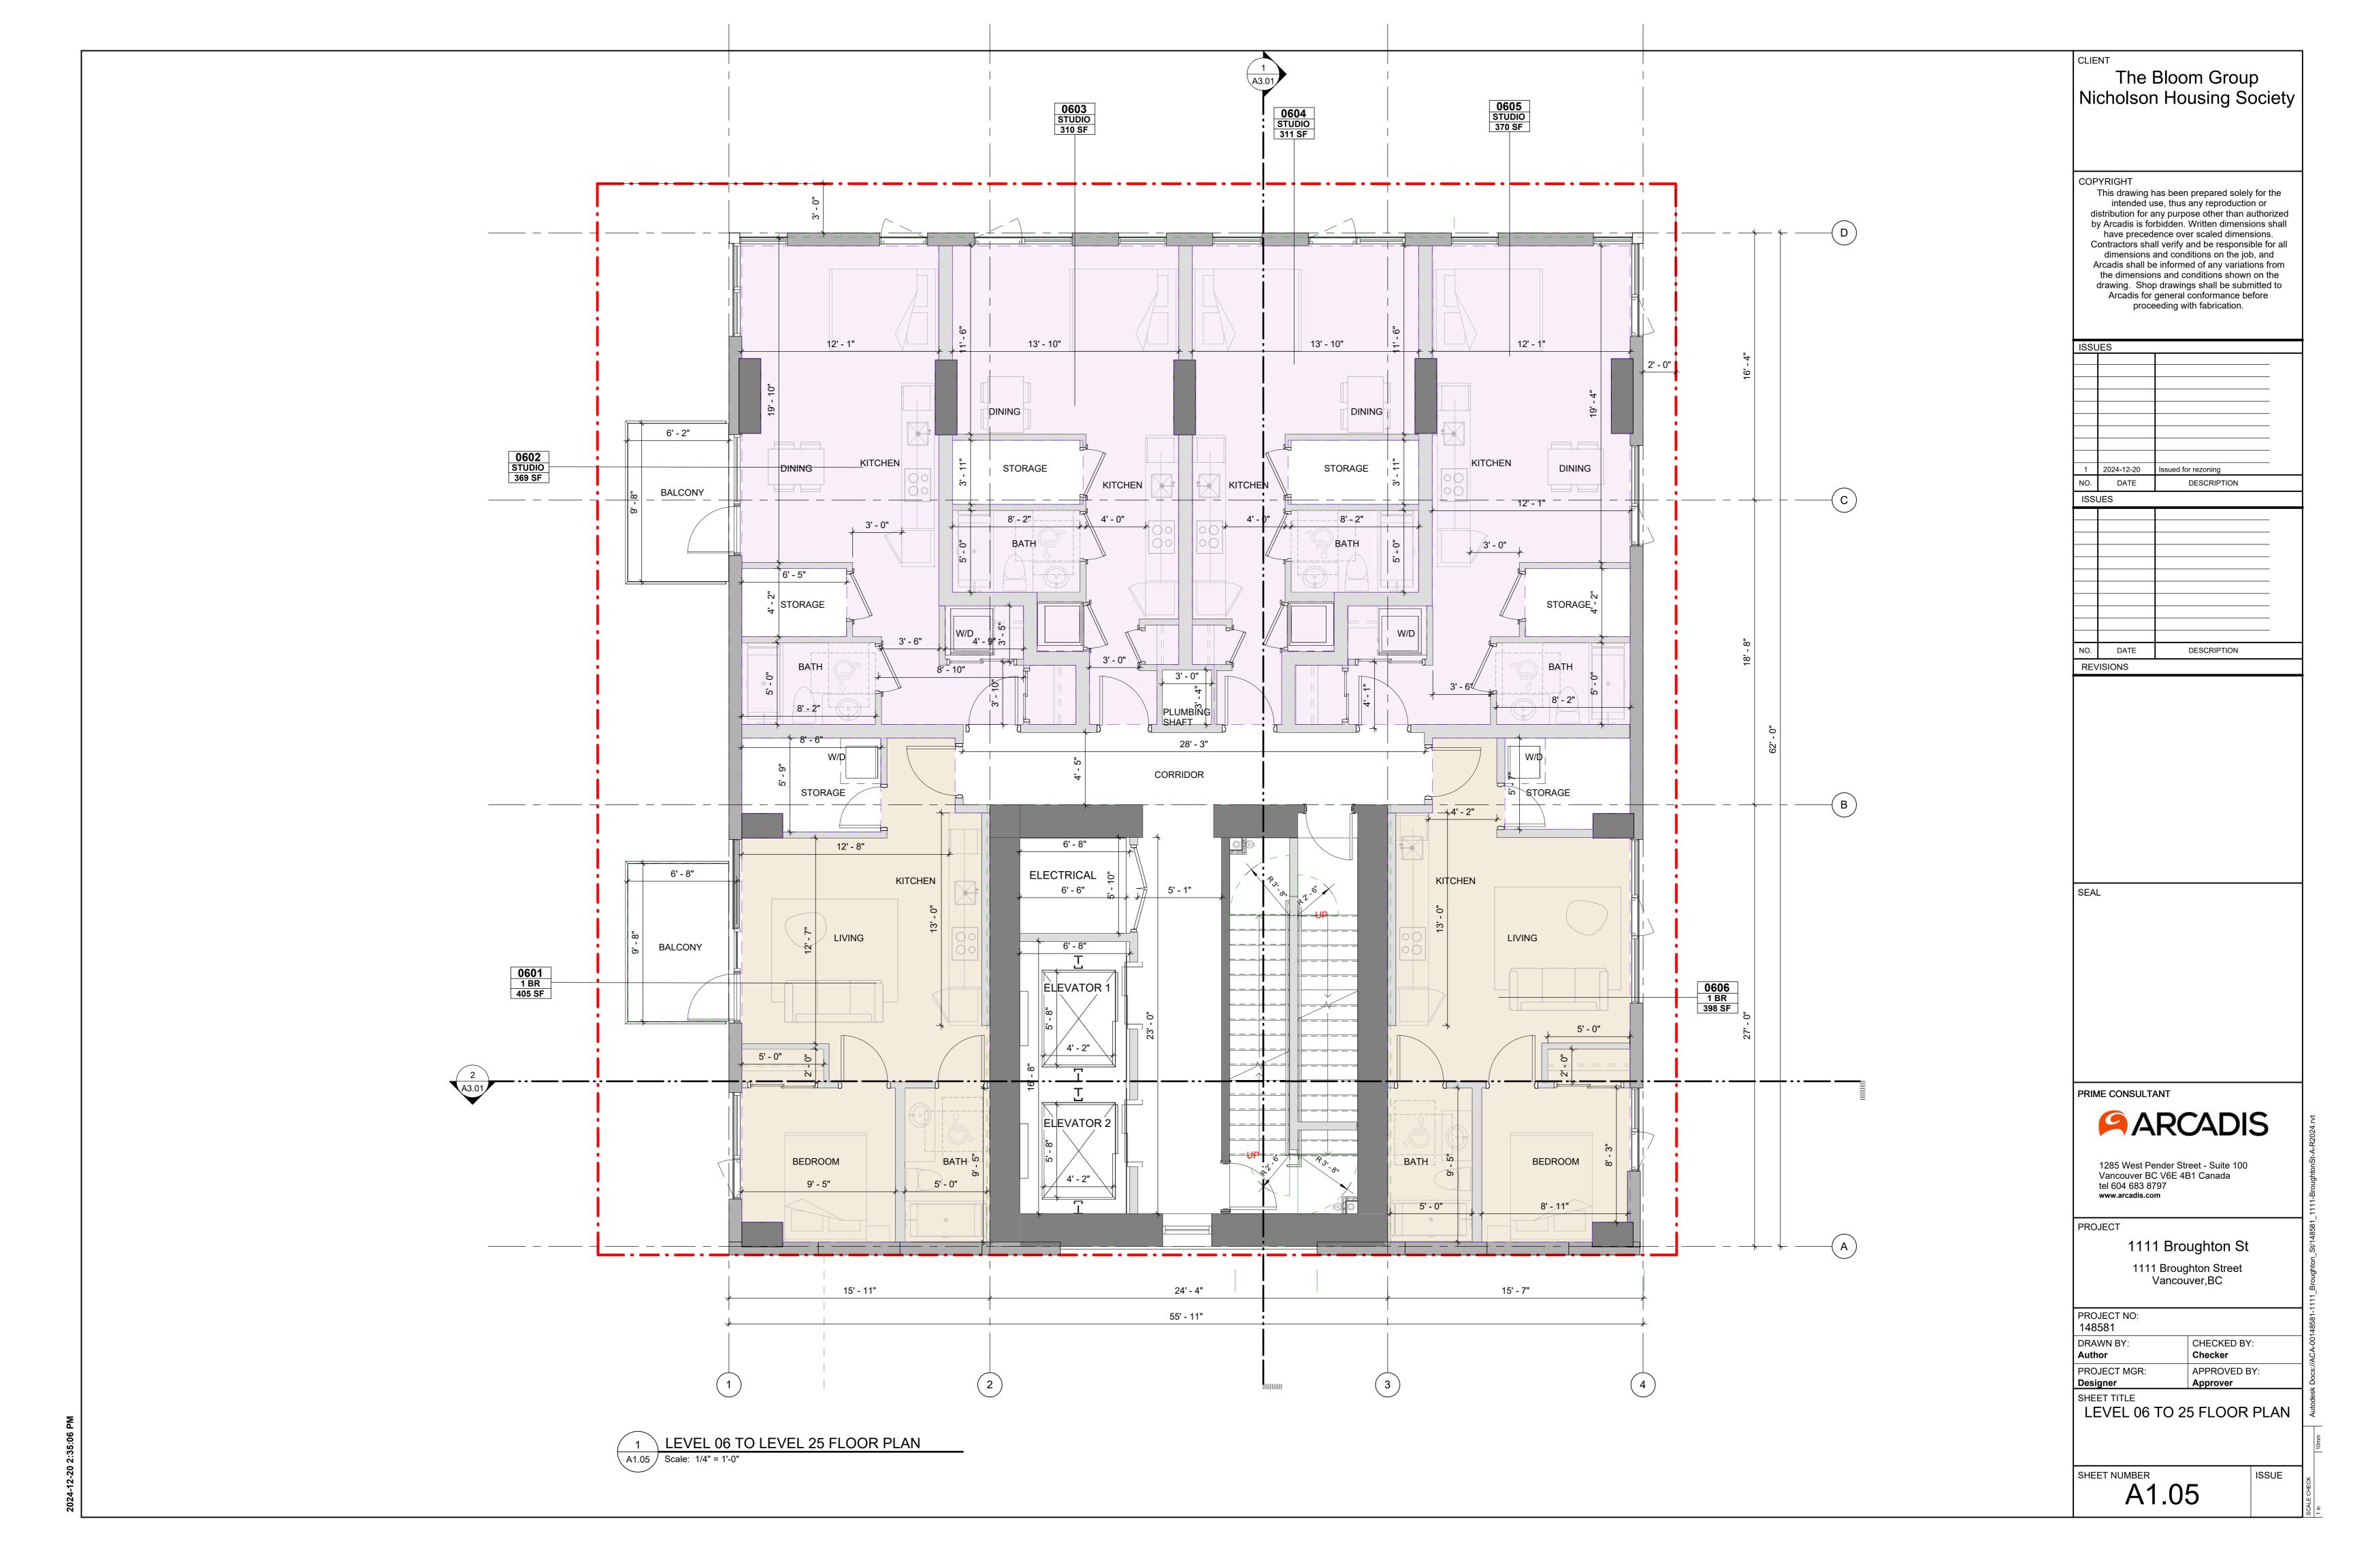

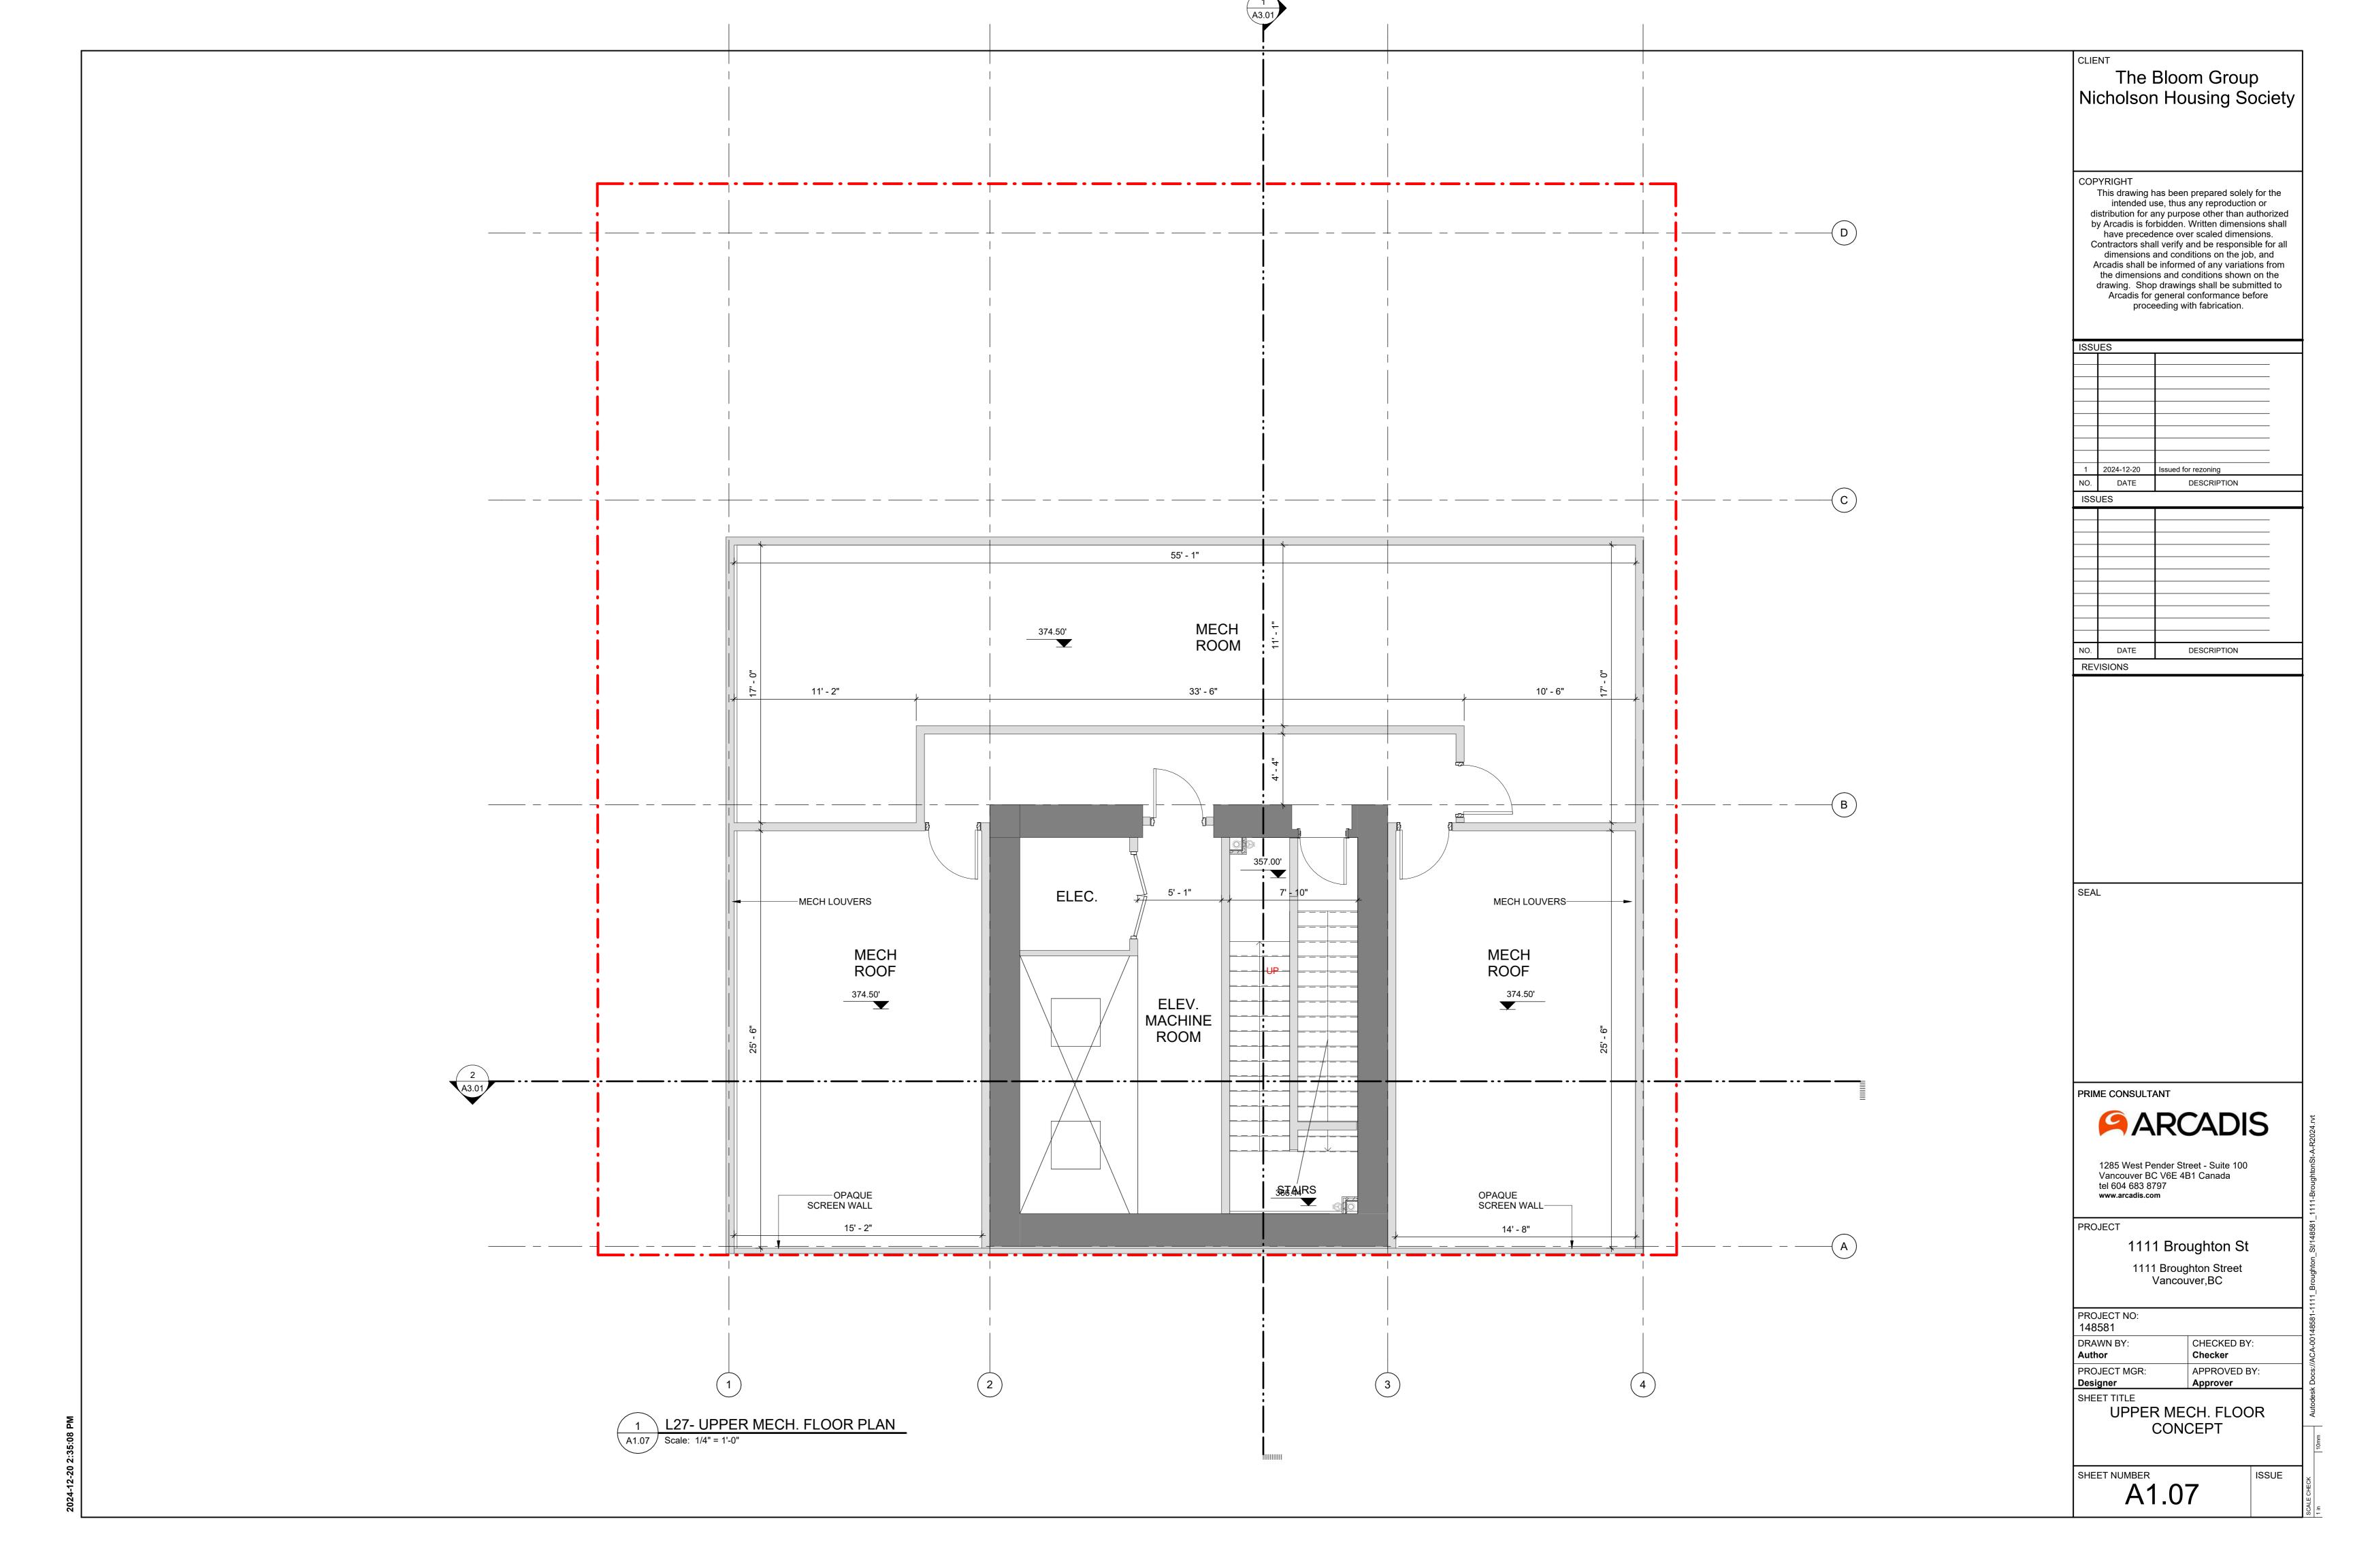

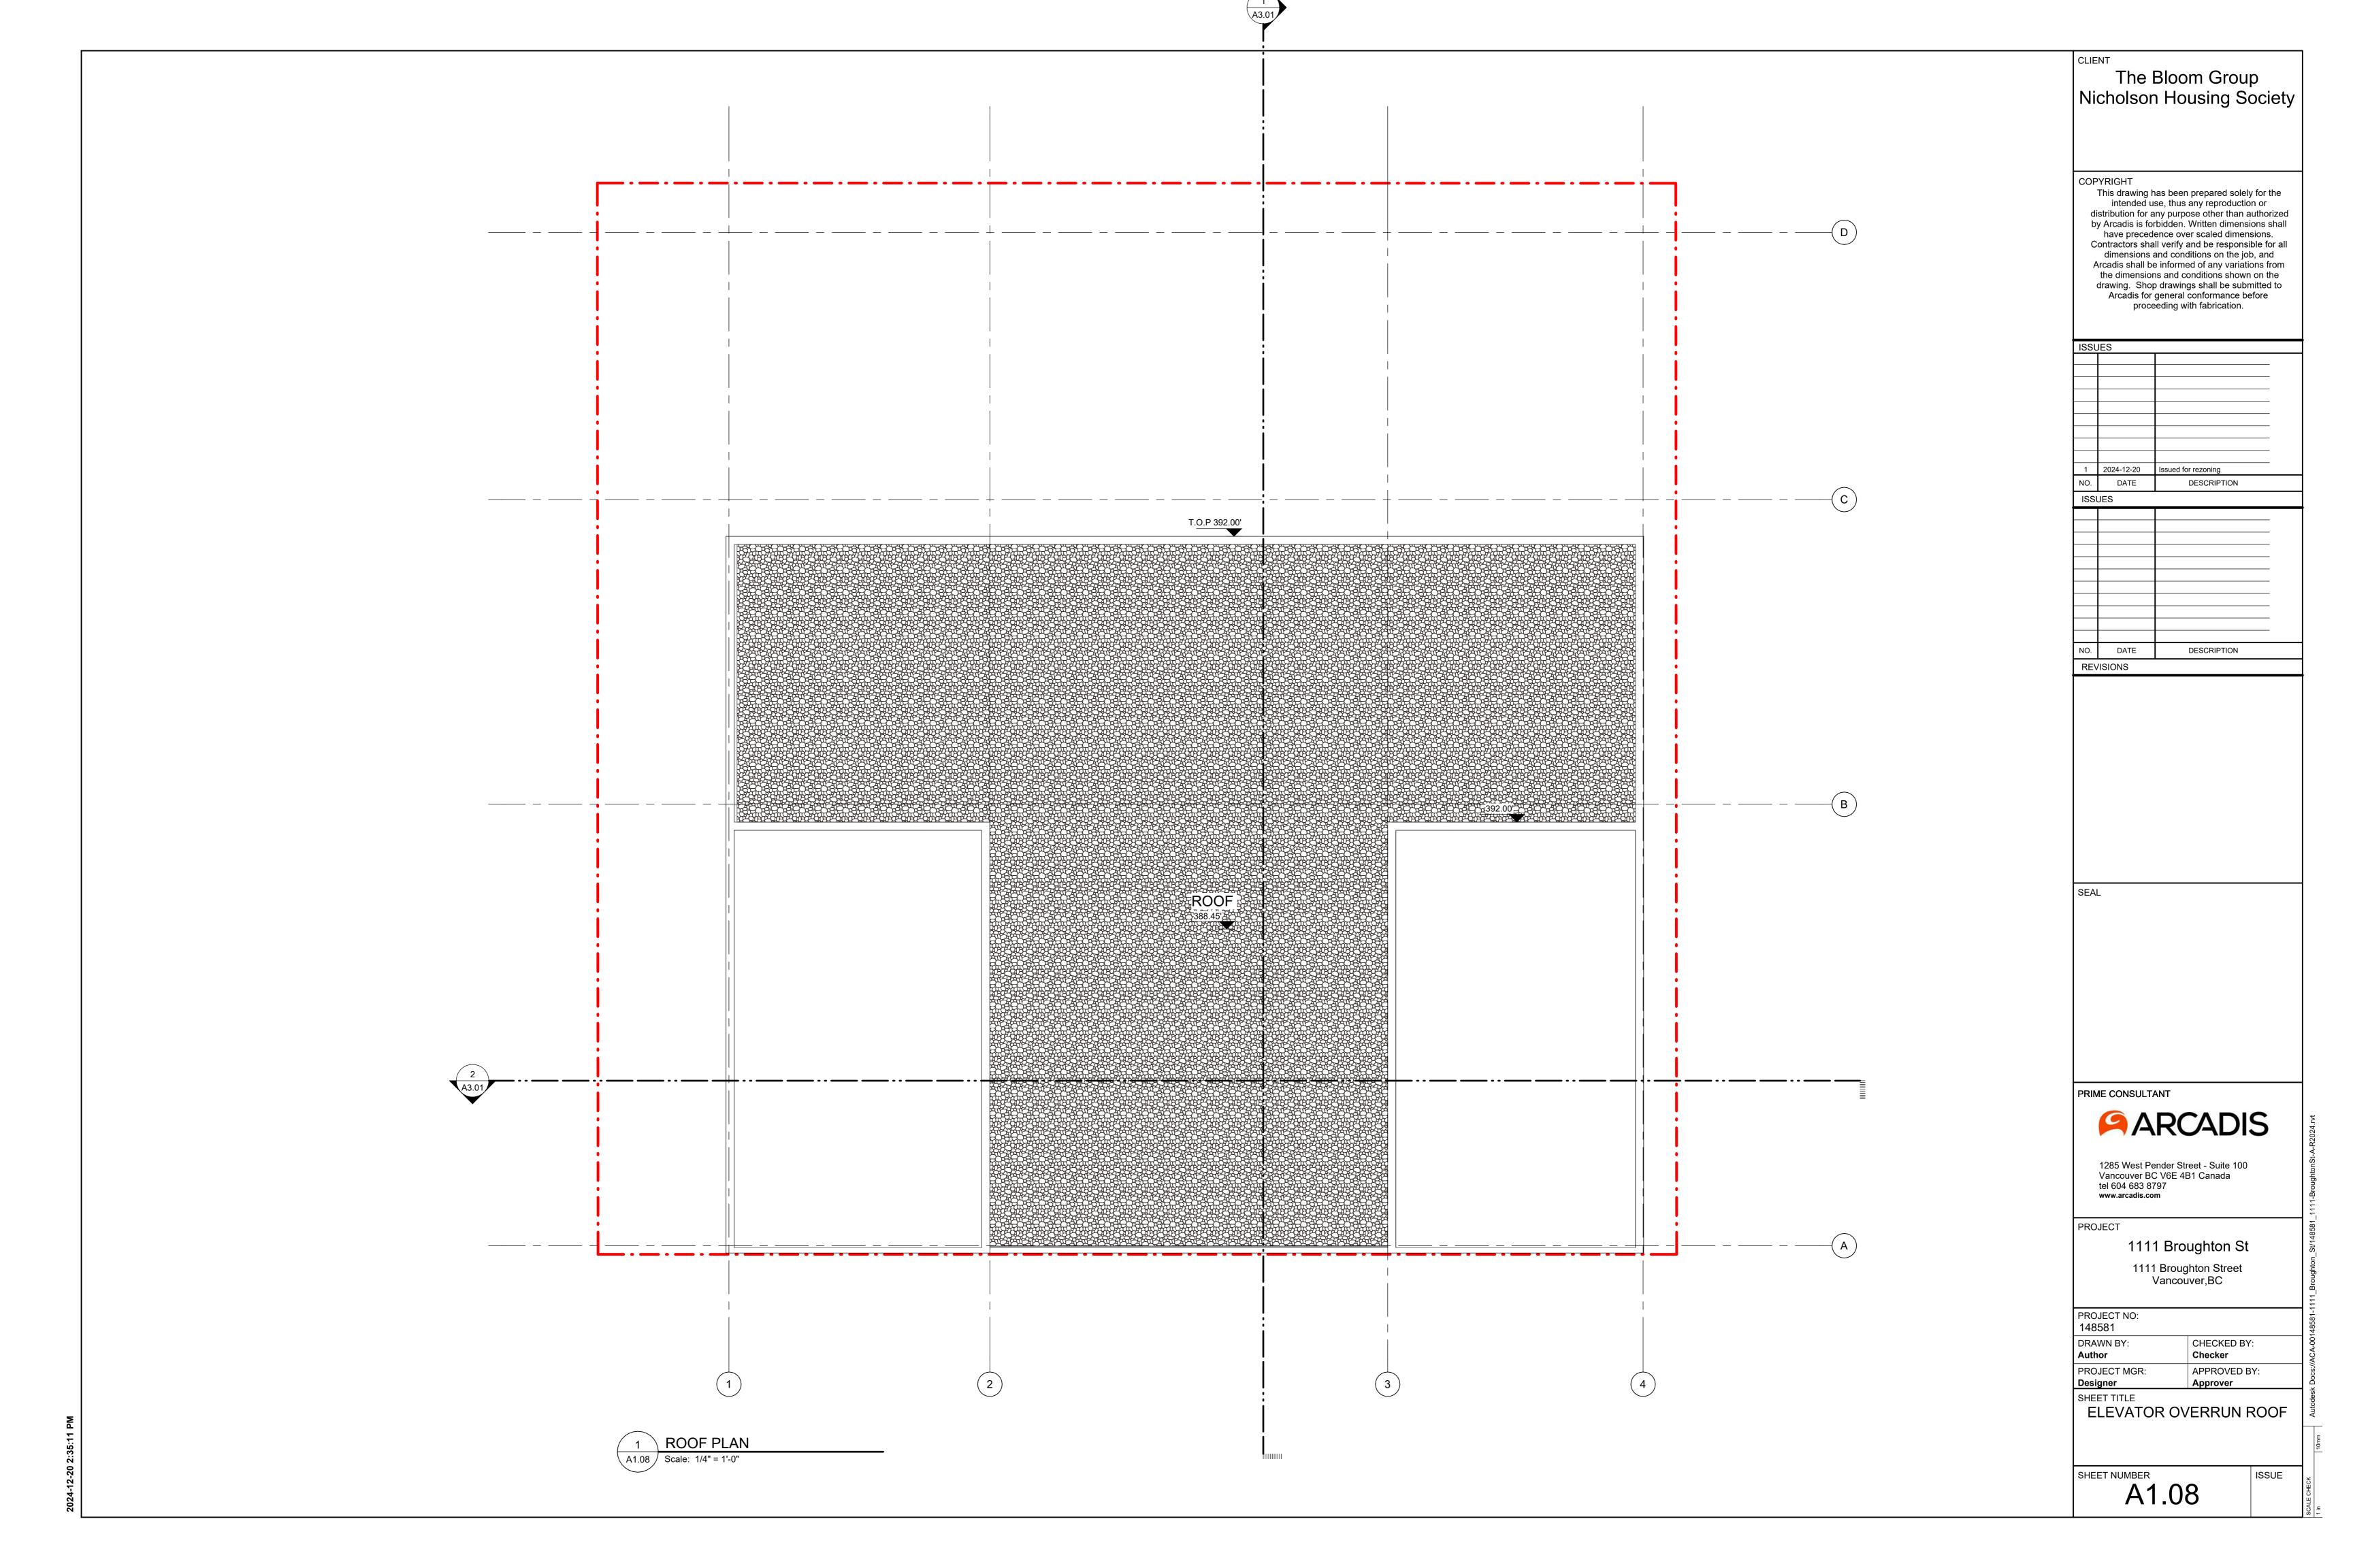WALL AREA: 16,980 SF WINDOW AREA: 5,308 SF % WINDOW: 31.2%



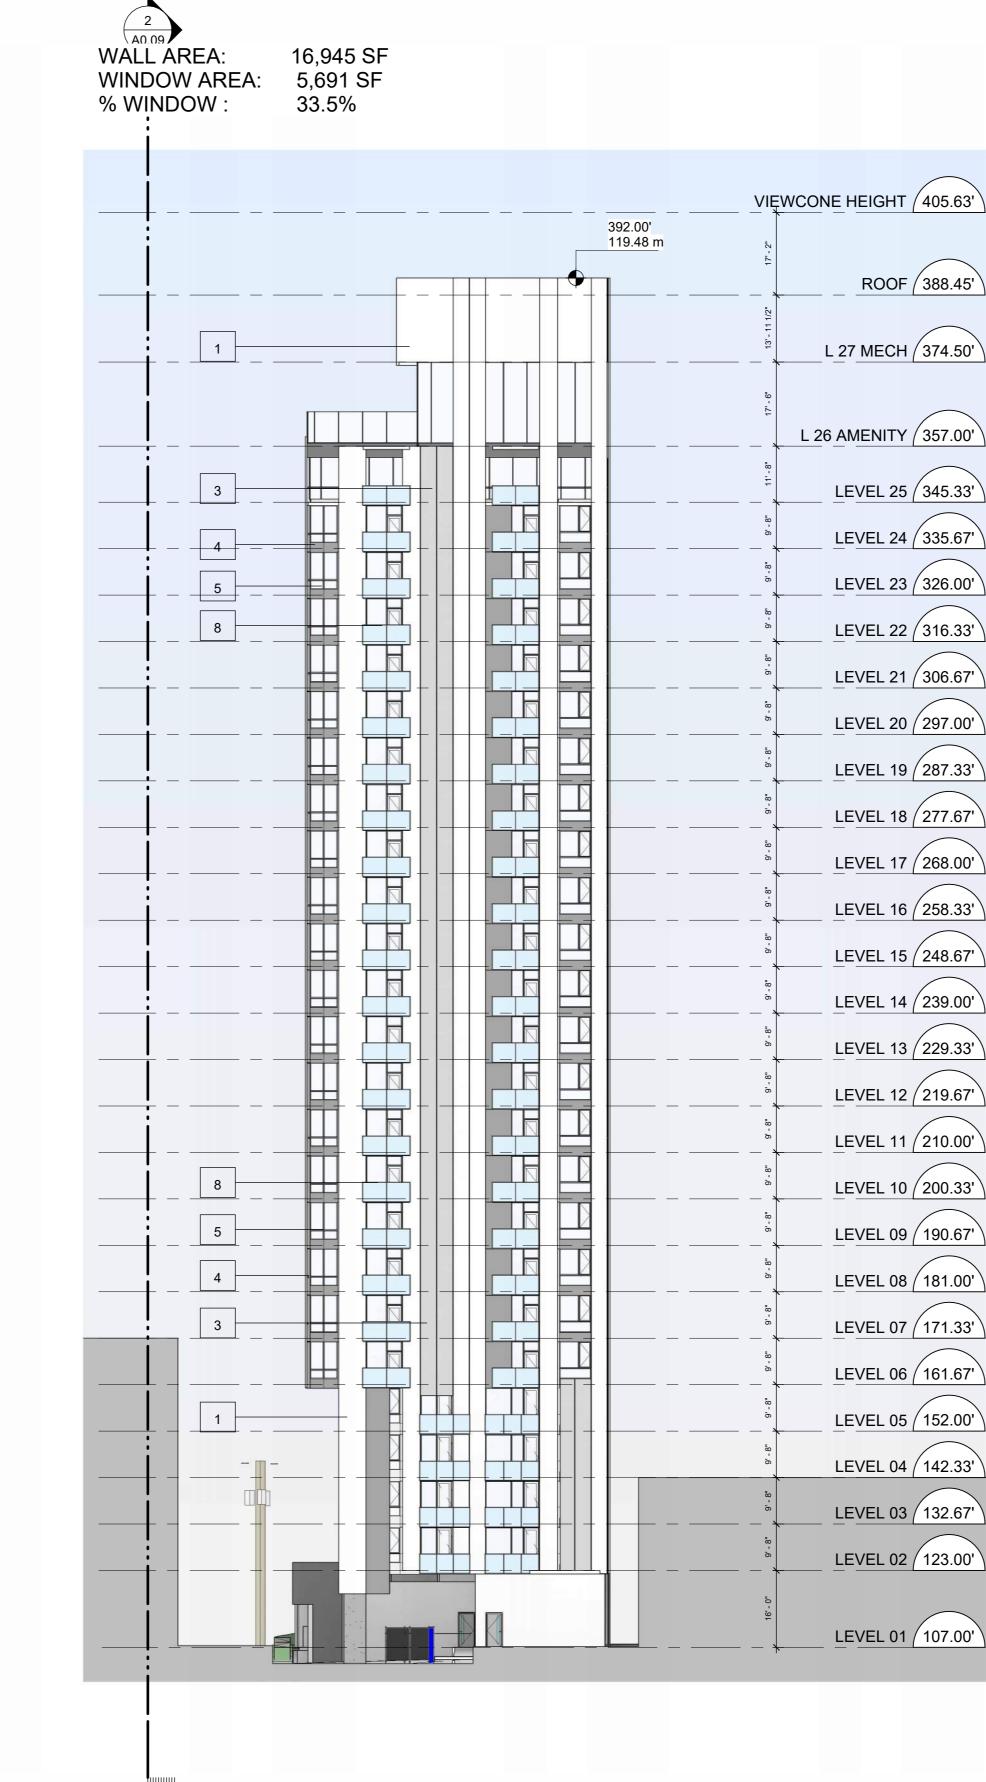

2 WEST ELEVATION

A2.01 | Scale: 1" = 20'-0"

1 - WHITE PEARL METAL PANEL

2 - CHAMPAGNE METAL PANEL

3 - SUNRISE SILVER METAL PANEL

4 - GRAPHITE MICA METAL PANEL

5 - WINDOW WALL - CHARCOAL GREY MULLIONS

6 - GLASS CANOPY

ROOF (388.45')

7 - MECH LOUVRES - CHARCOAL GREY

8 - GLASS BALCONY GUARDRAIL - CHARCOAL GREY FRAMING

9 - FRITTED GLASS PRIVACY SCREENS - CHARCOAL **GREY FRAMING**

10 - PAINTED CONCRETE

11 - BALCONY SOFFIT WHITE

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SHEET TITLE EAST AND WEST ELEVATION

SHEET NUMBER


A2.01

EAST ELEVATION A2.01 | Scale: 1" = 20'-0"


TOTAL WALL AREA: WINDOW AREA: % WINDOW:

15,893 SF

5,590 SF

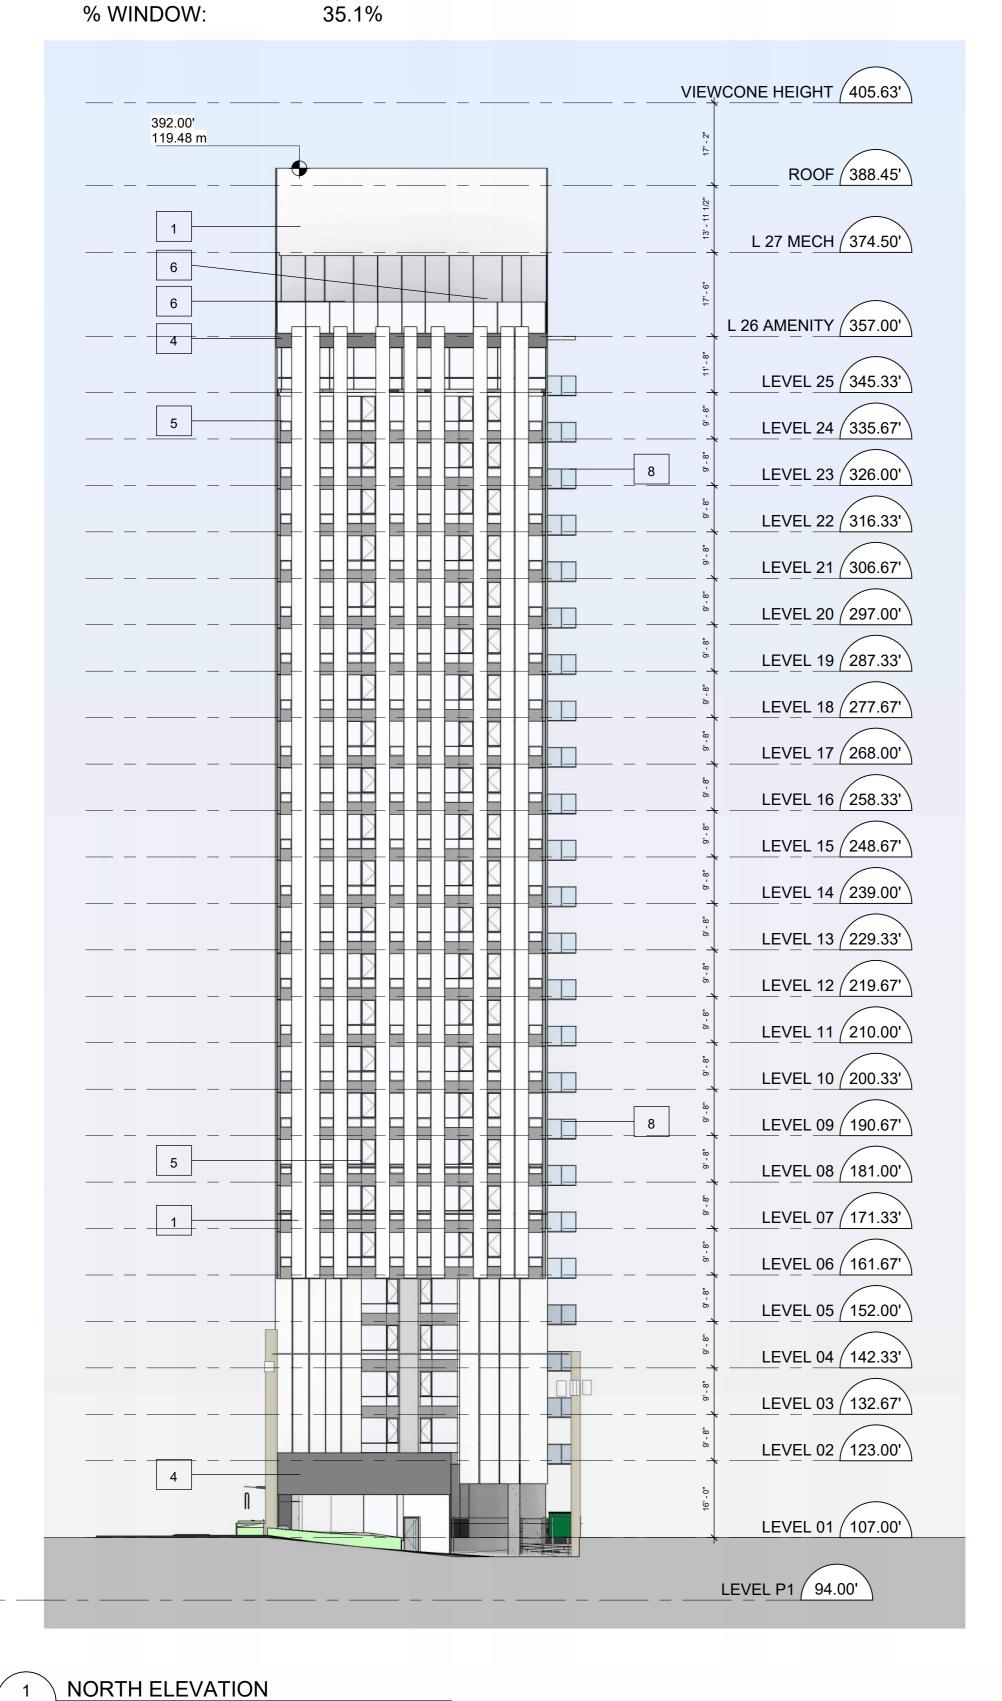

TOTAL WALL AREA: 15,933SF WINDOW AREA: 408 SF 2.5%

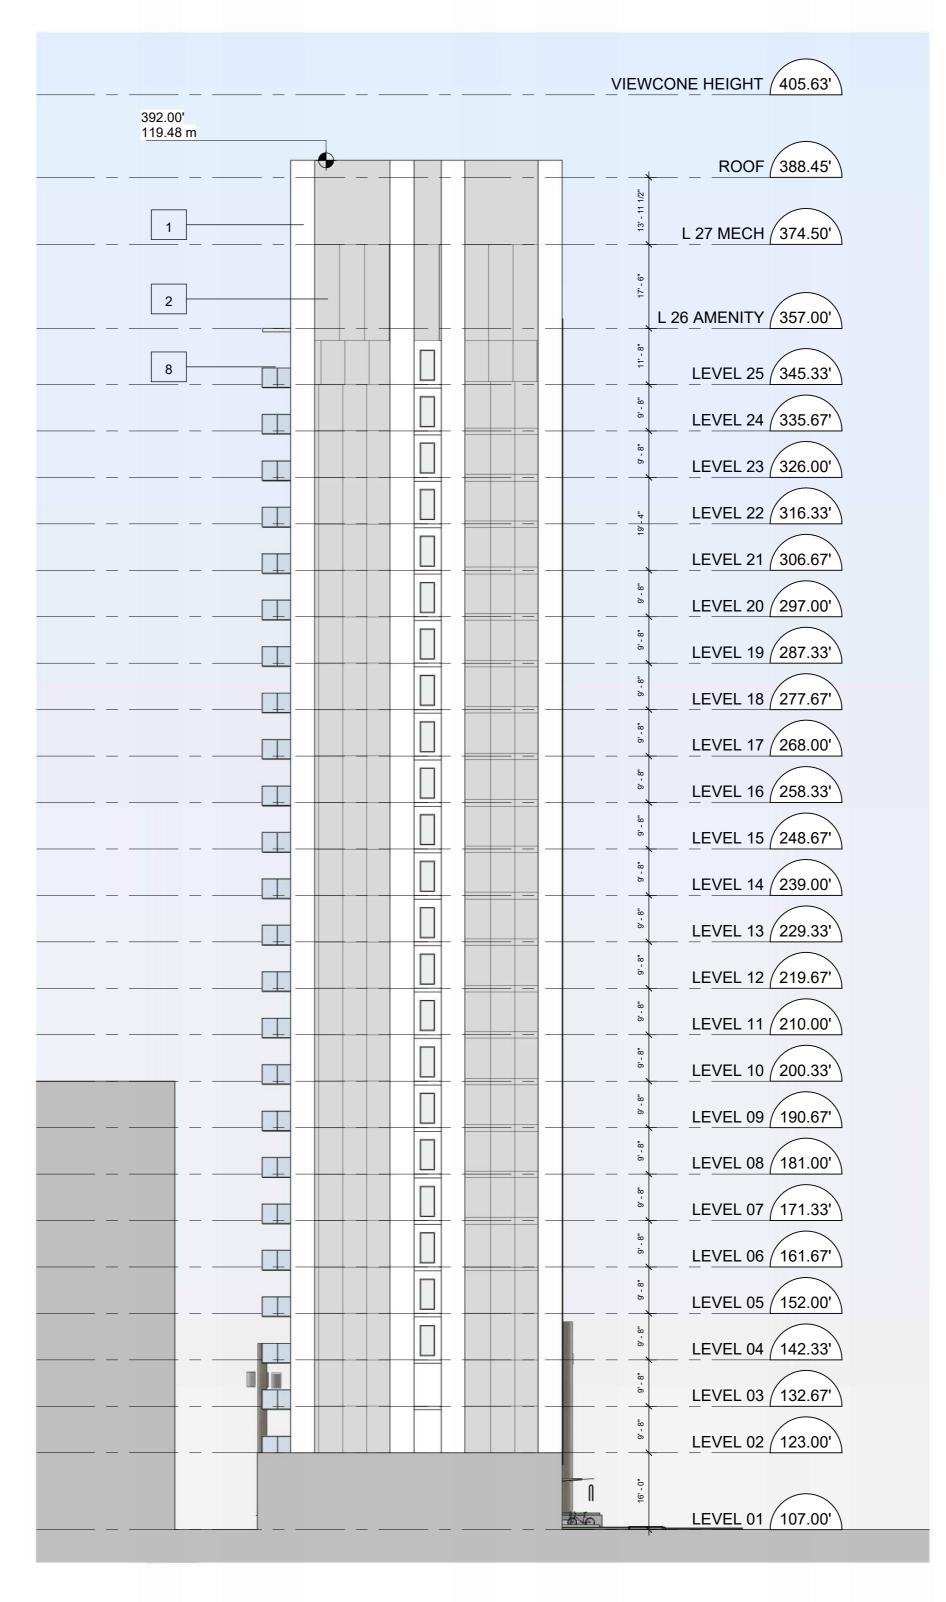

1 - WHITE PEARL METAL PANEL

2 - CHAMPAGNE METAL PANEL

3 - SUNRISE SILVER METAL PANEL

4 - GRAPHITE MICA METAL PANEL

5 - WINDOW WALL - CHARCOAL GREY MULLIONS

6 - GLASS CANOPY

7 - MECH LOUVRES - CHARCOAL GREY

8 - GLASS BALCONY GUARDRAIL - CHARCOAL GREY FRAMING

9 - FRITTED GLASS PRIVACY SCREENS - CHARCOAL GREY FRAMING

10 - PAINTED CONCRETE

11 - BALCONY SOFFIT WHITE

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SHEET TITLE

NORTH AND SOUTH


ELEVATION


ISSUE

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A2.02

2 SOUTH ELEVATION
A2.02 Scale: 1" = 20'-0"

A2.02 | SCALE: 1" = 20'-0"

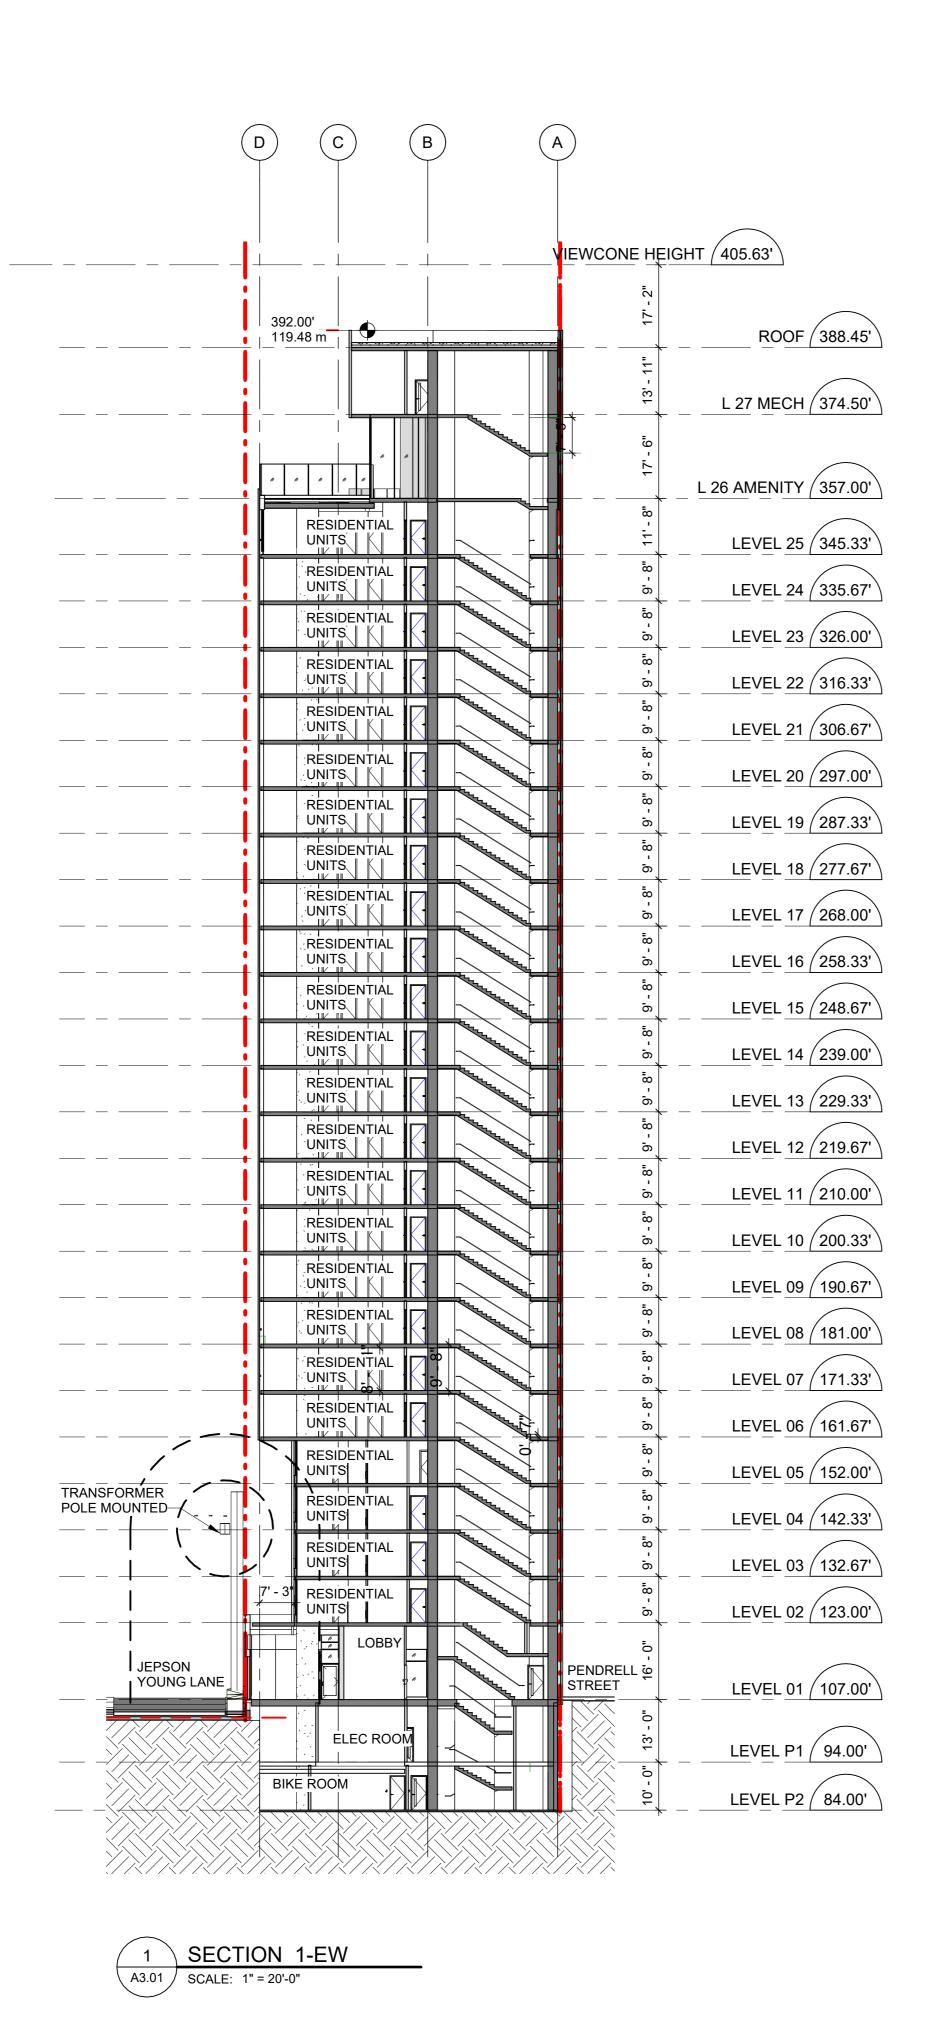

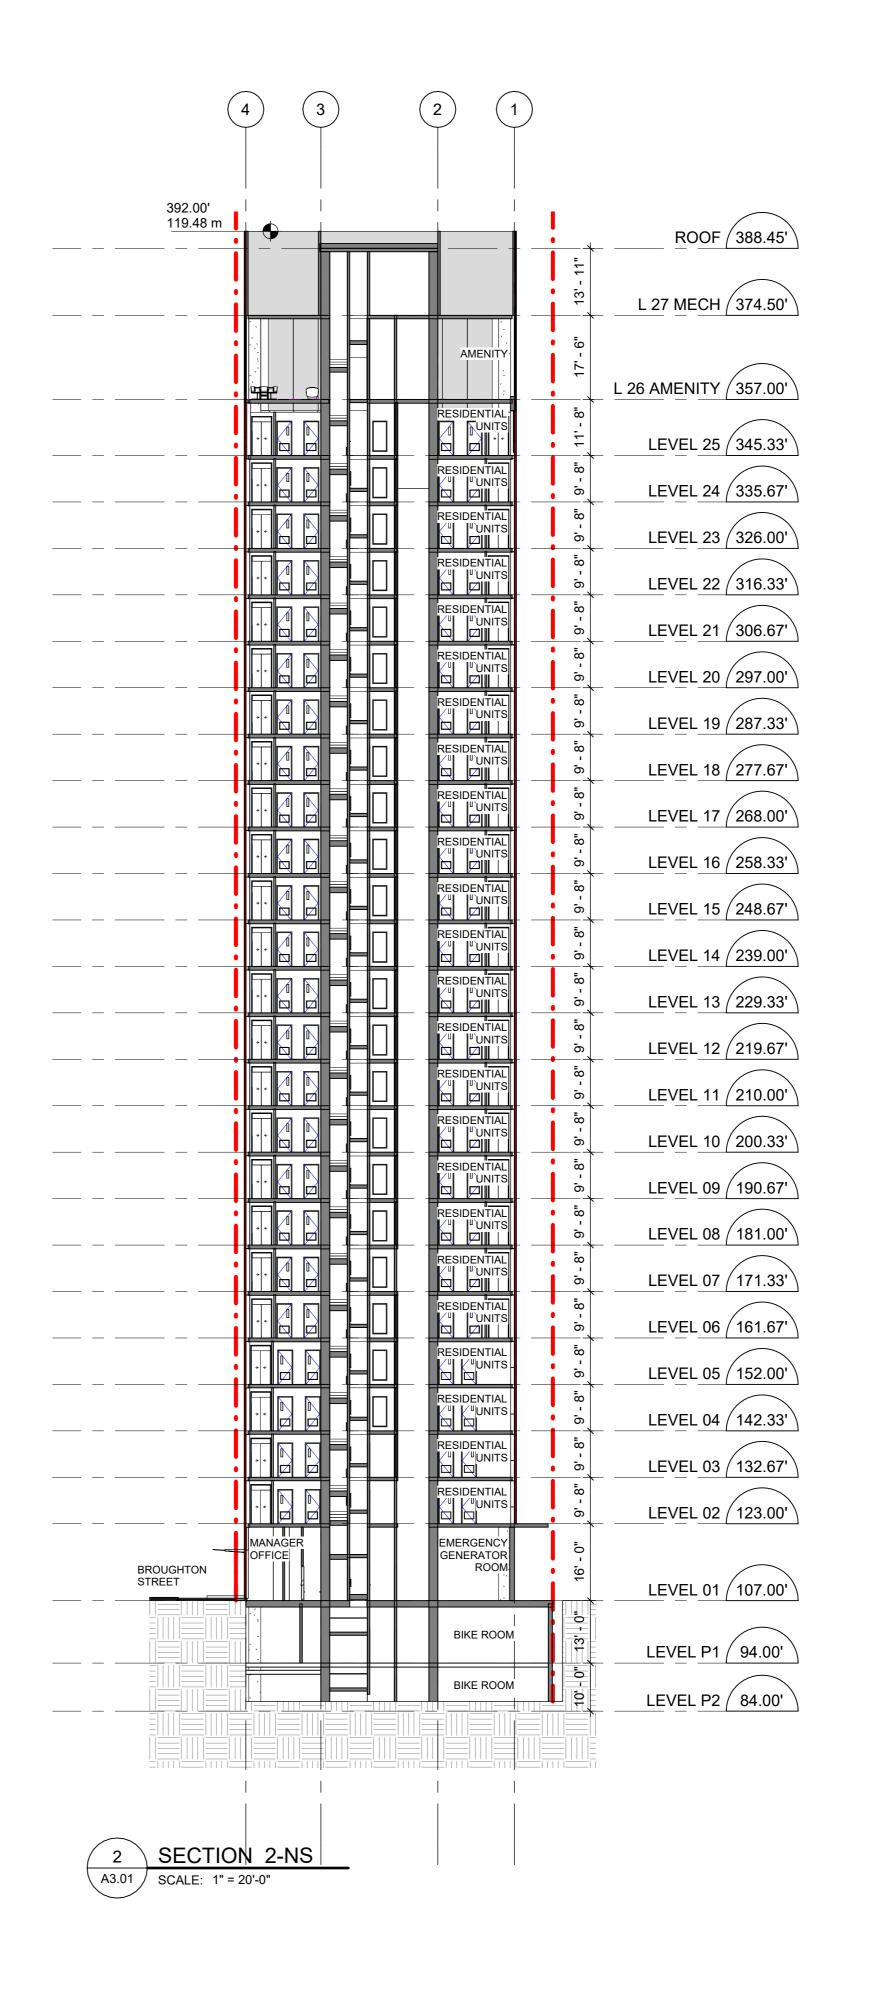

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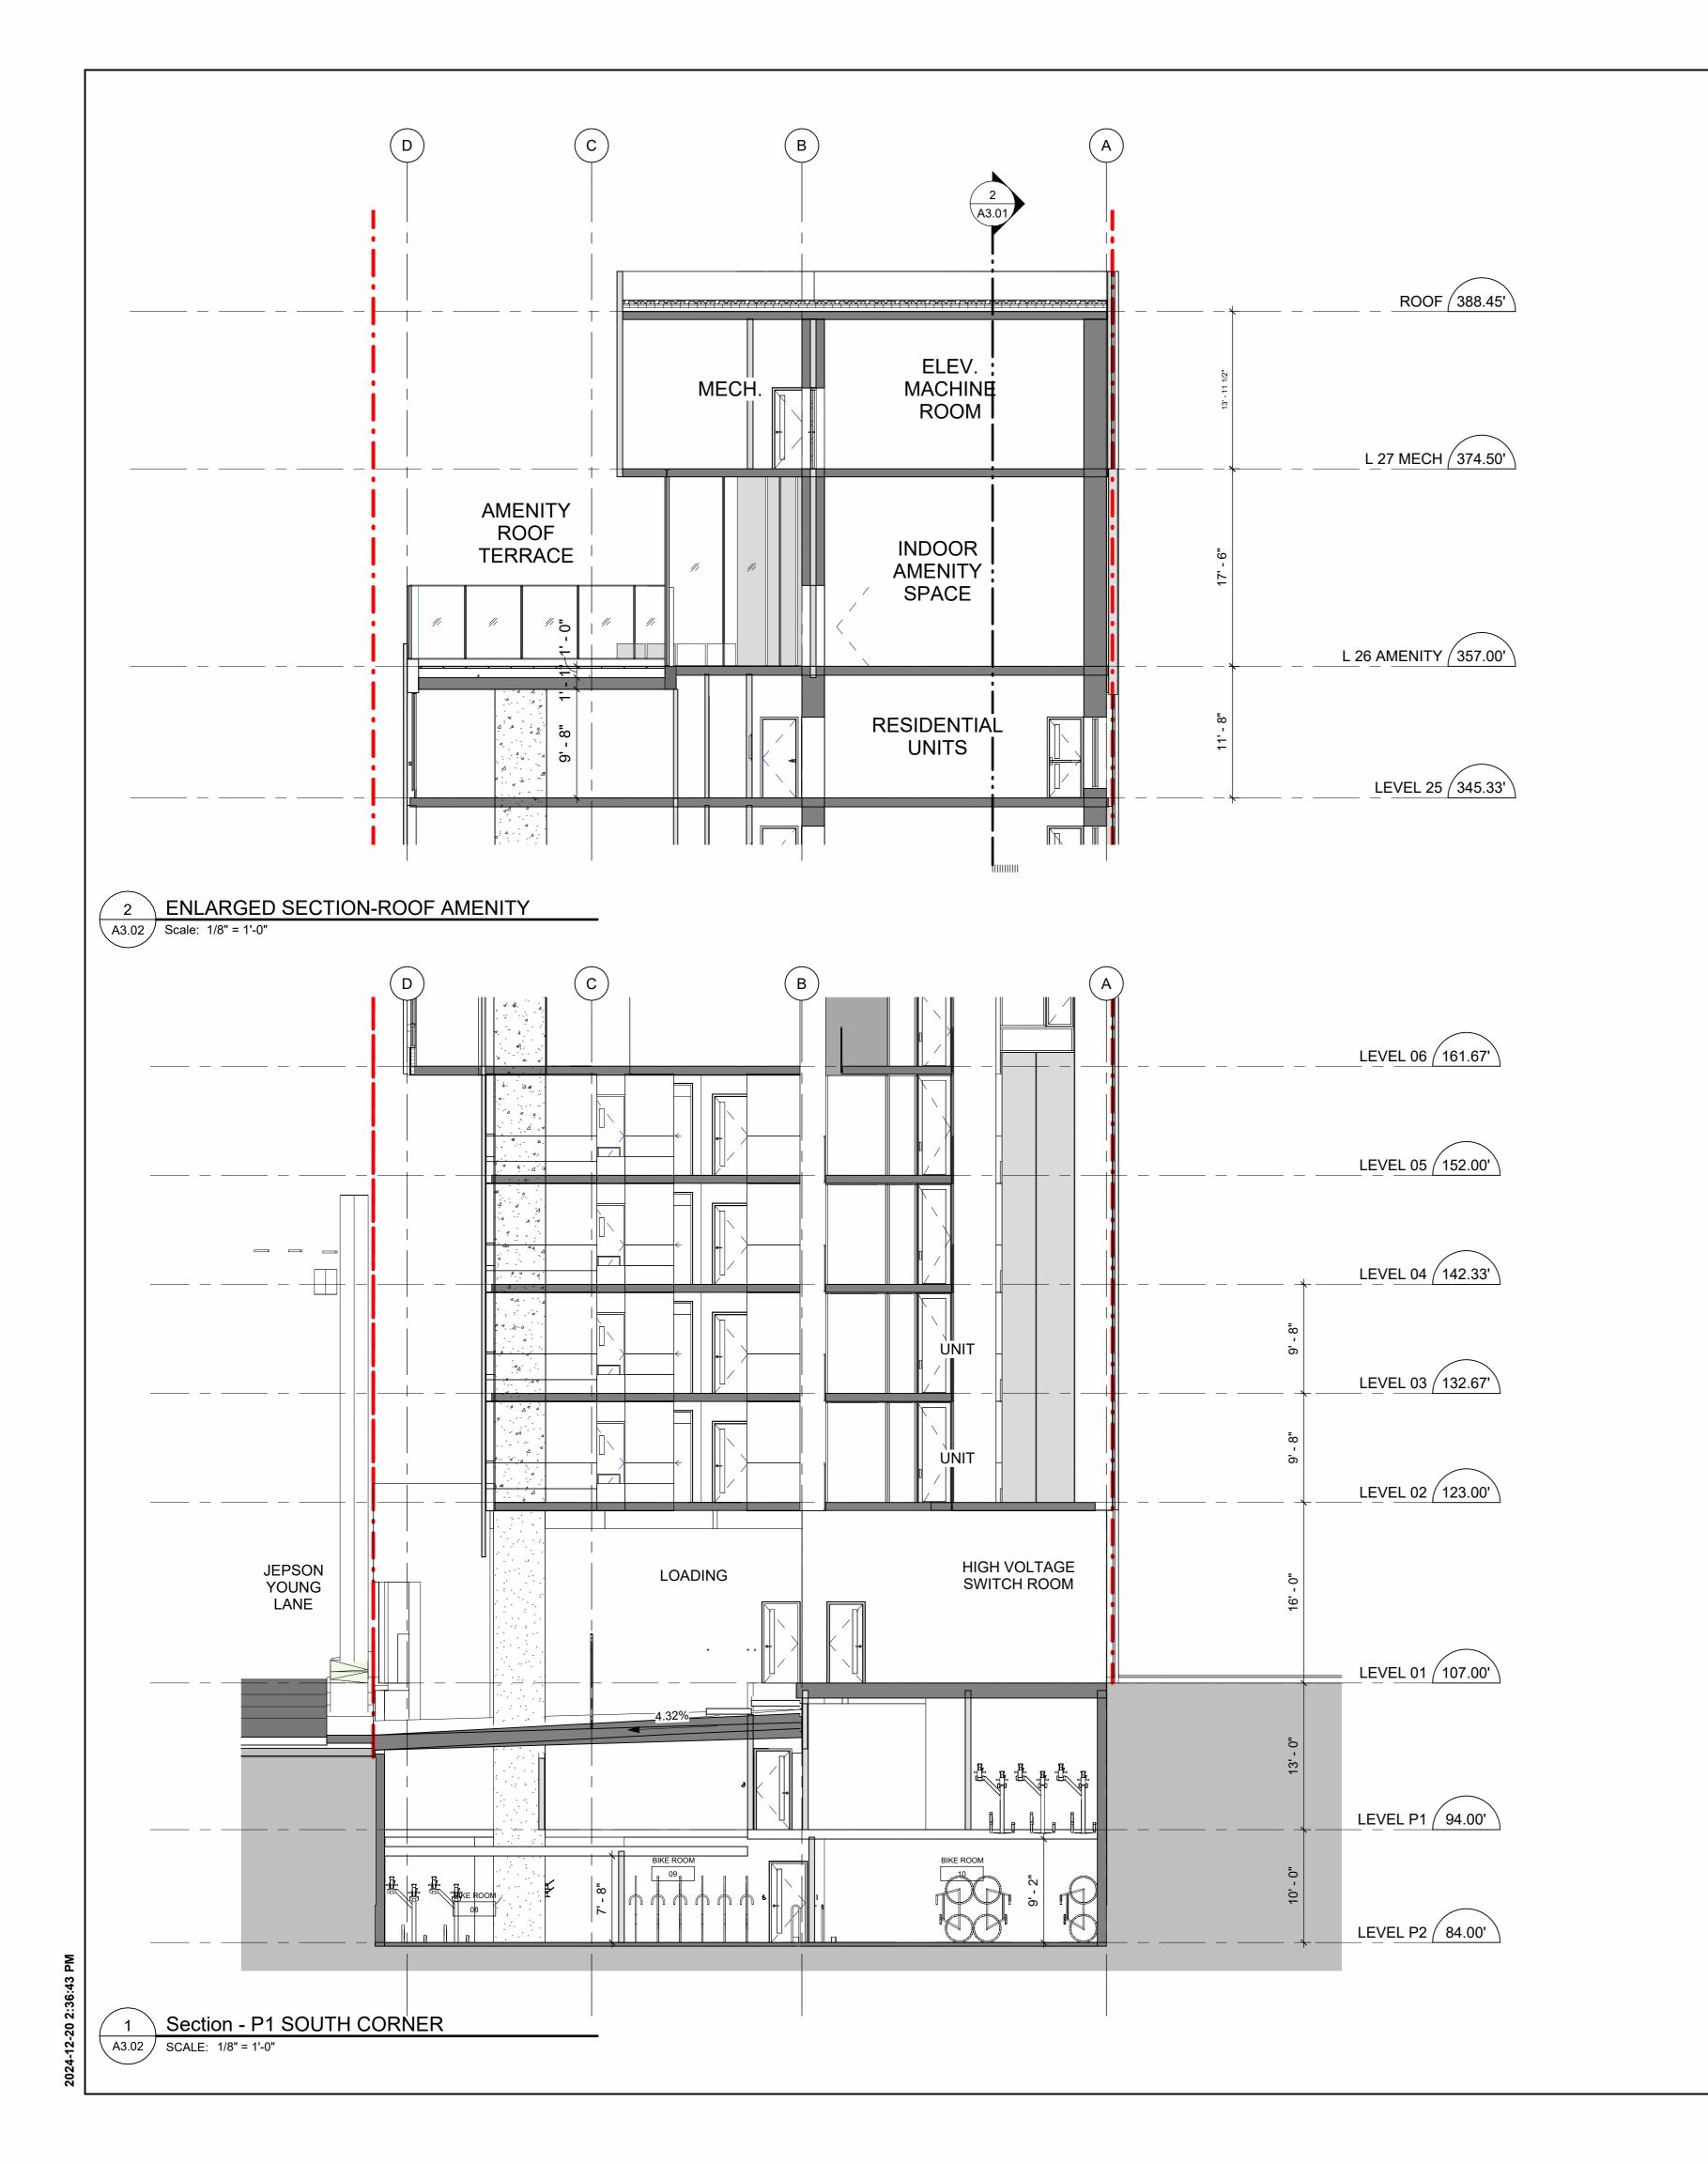
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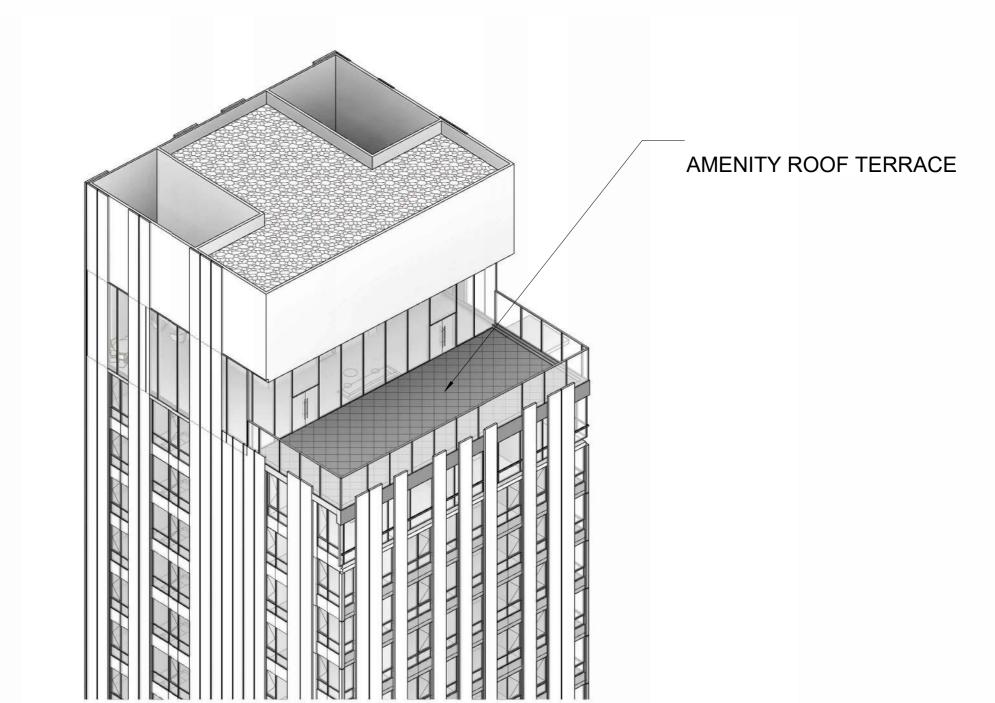
ISSUE

CHECKED BY:

SHEET TITLE **BUILDING SECTIONS**

SHEET NUMBER A3.01





3 AMENITY ROOF A3.02 SCALE:



4 TOWER BASE A3.02 SCALE:

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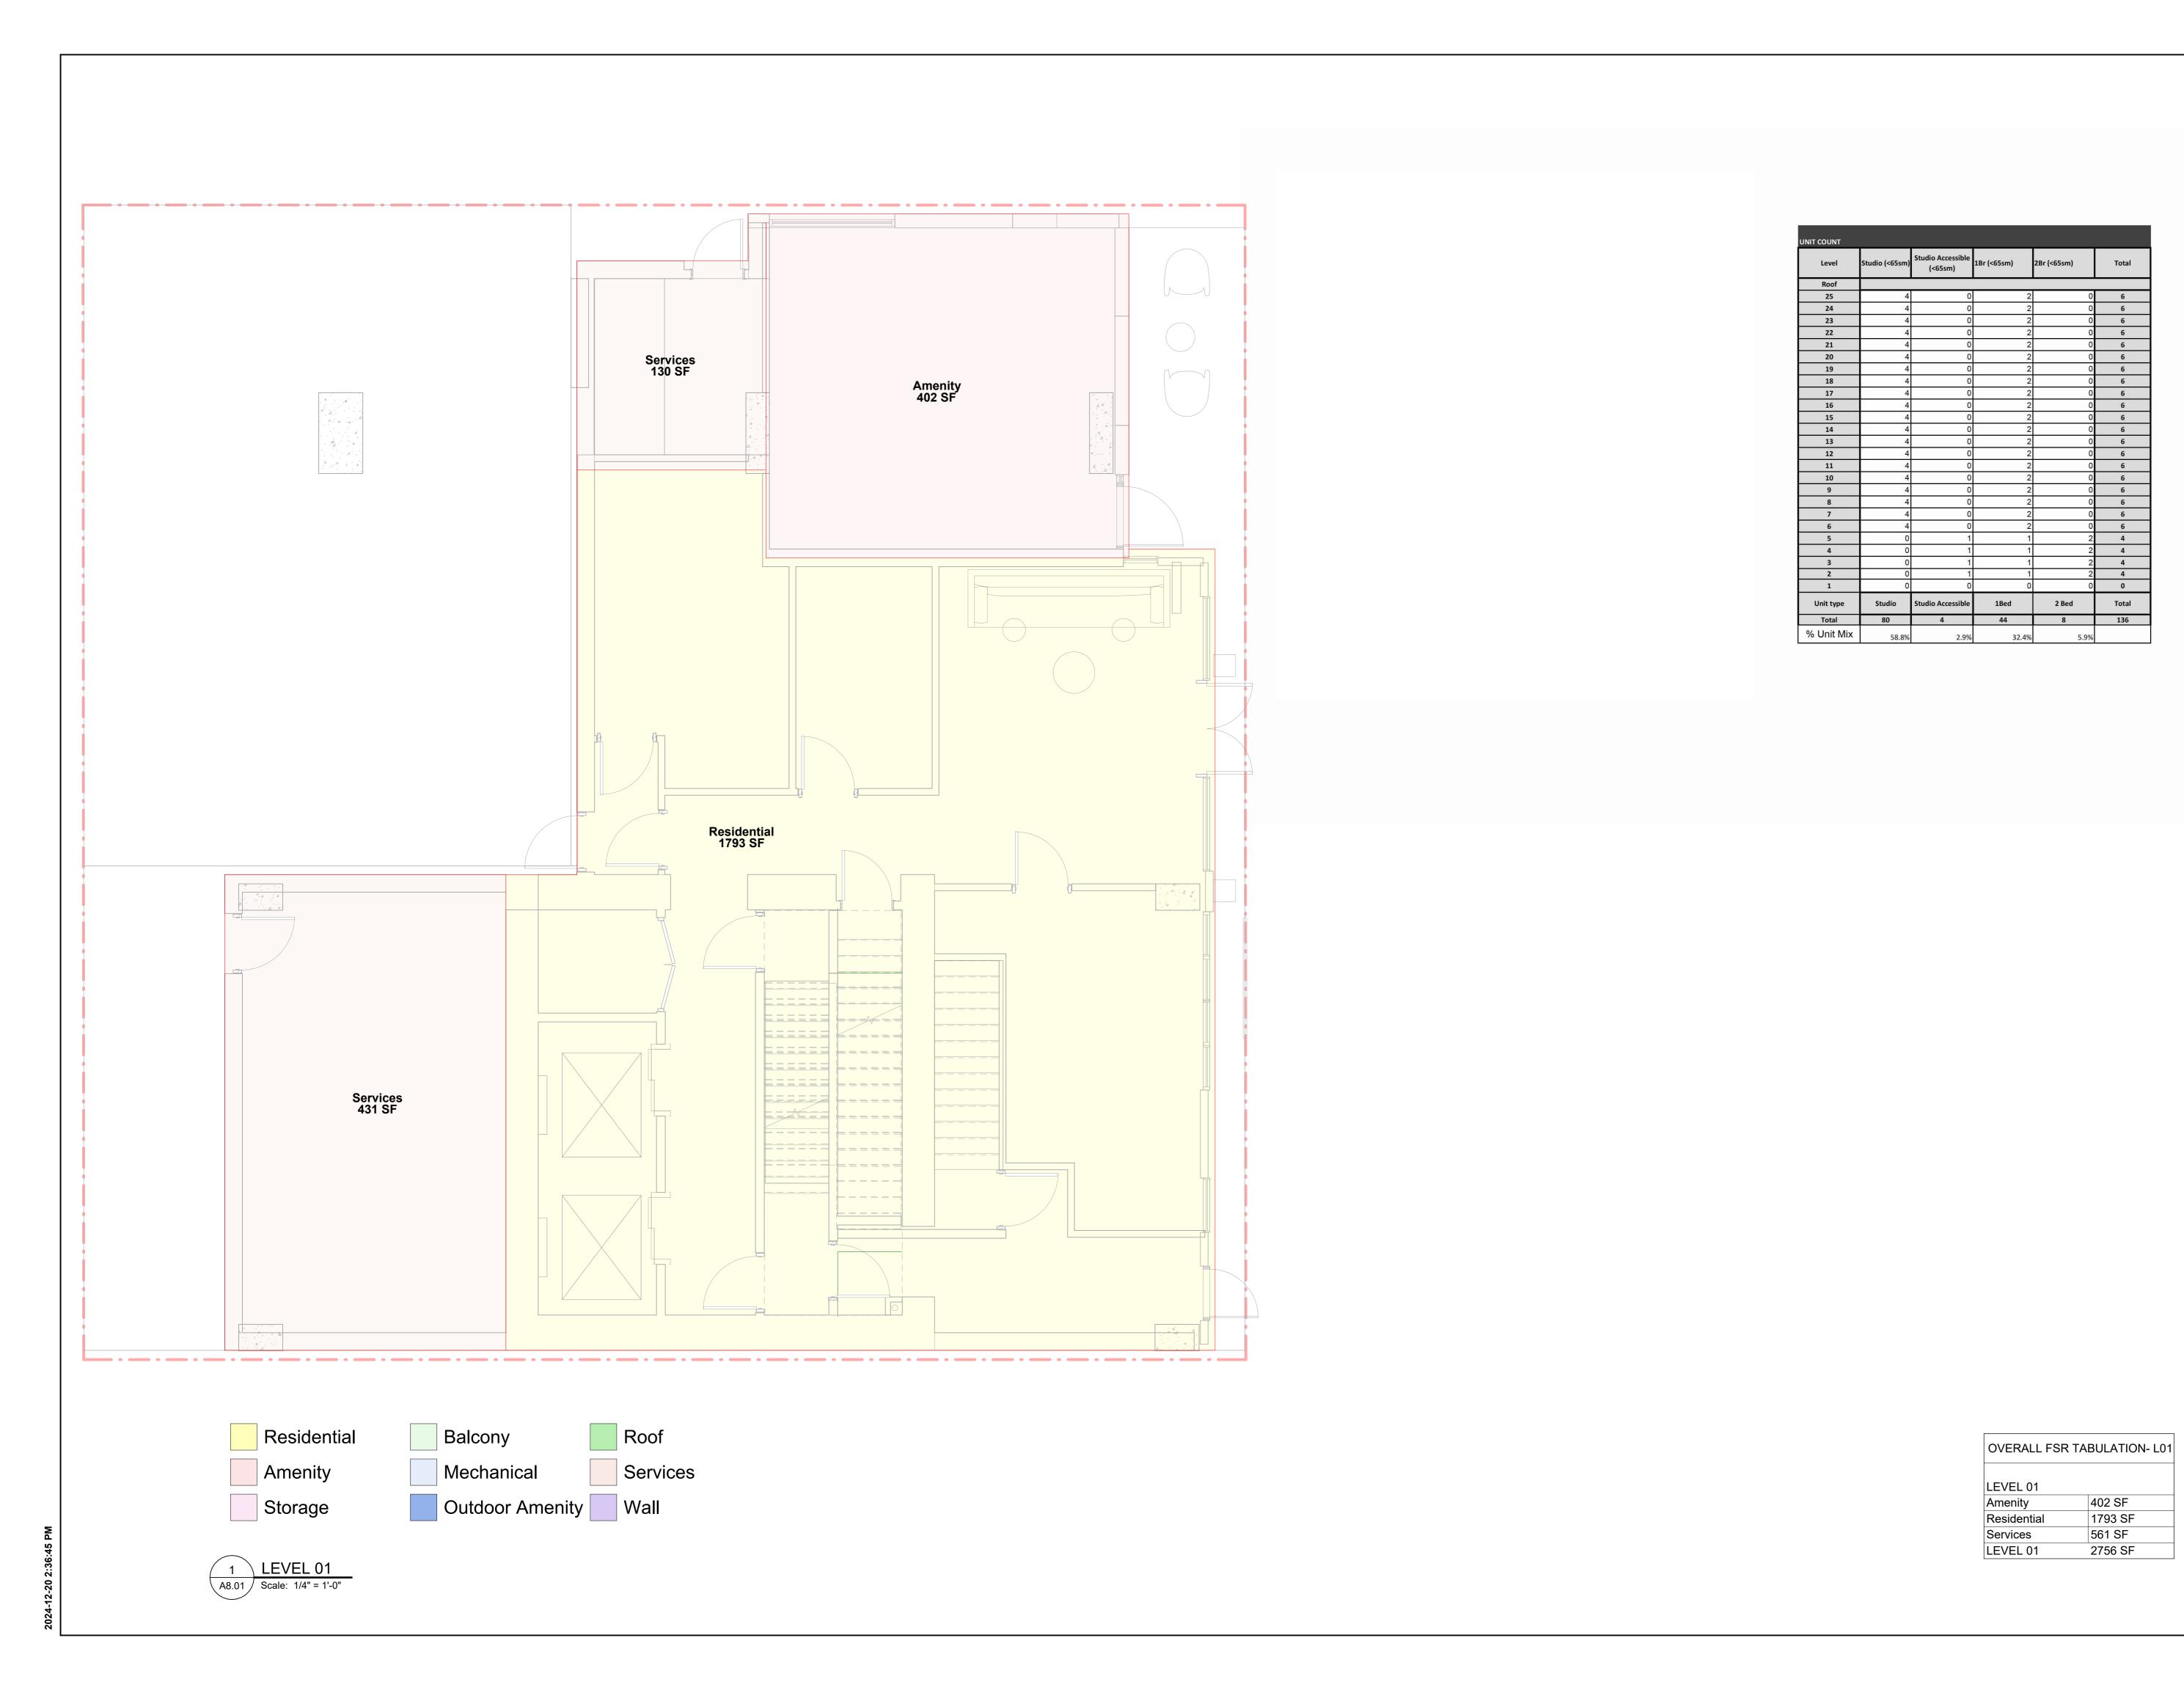
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Designer SHEET TITLE ENLARGED SECTIONS, ROOF AND LOADING

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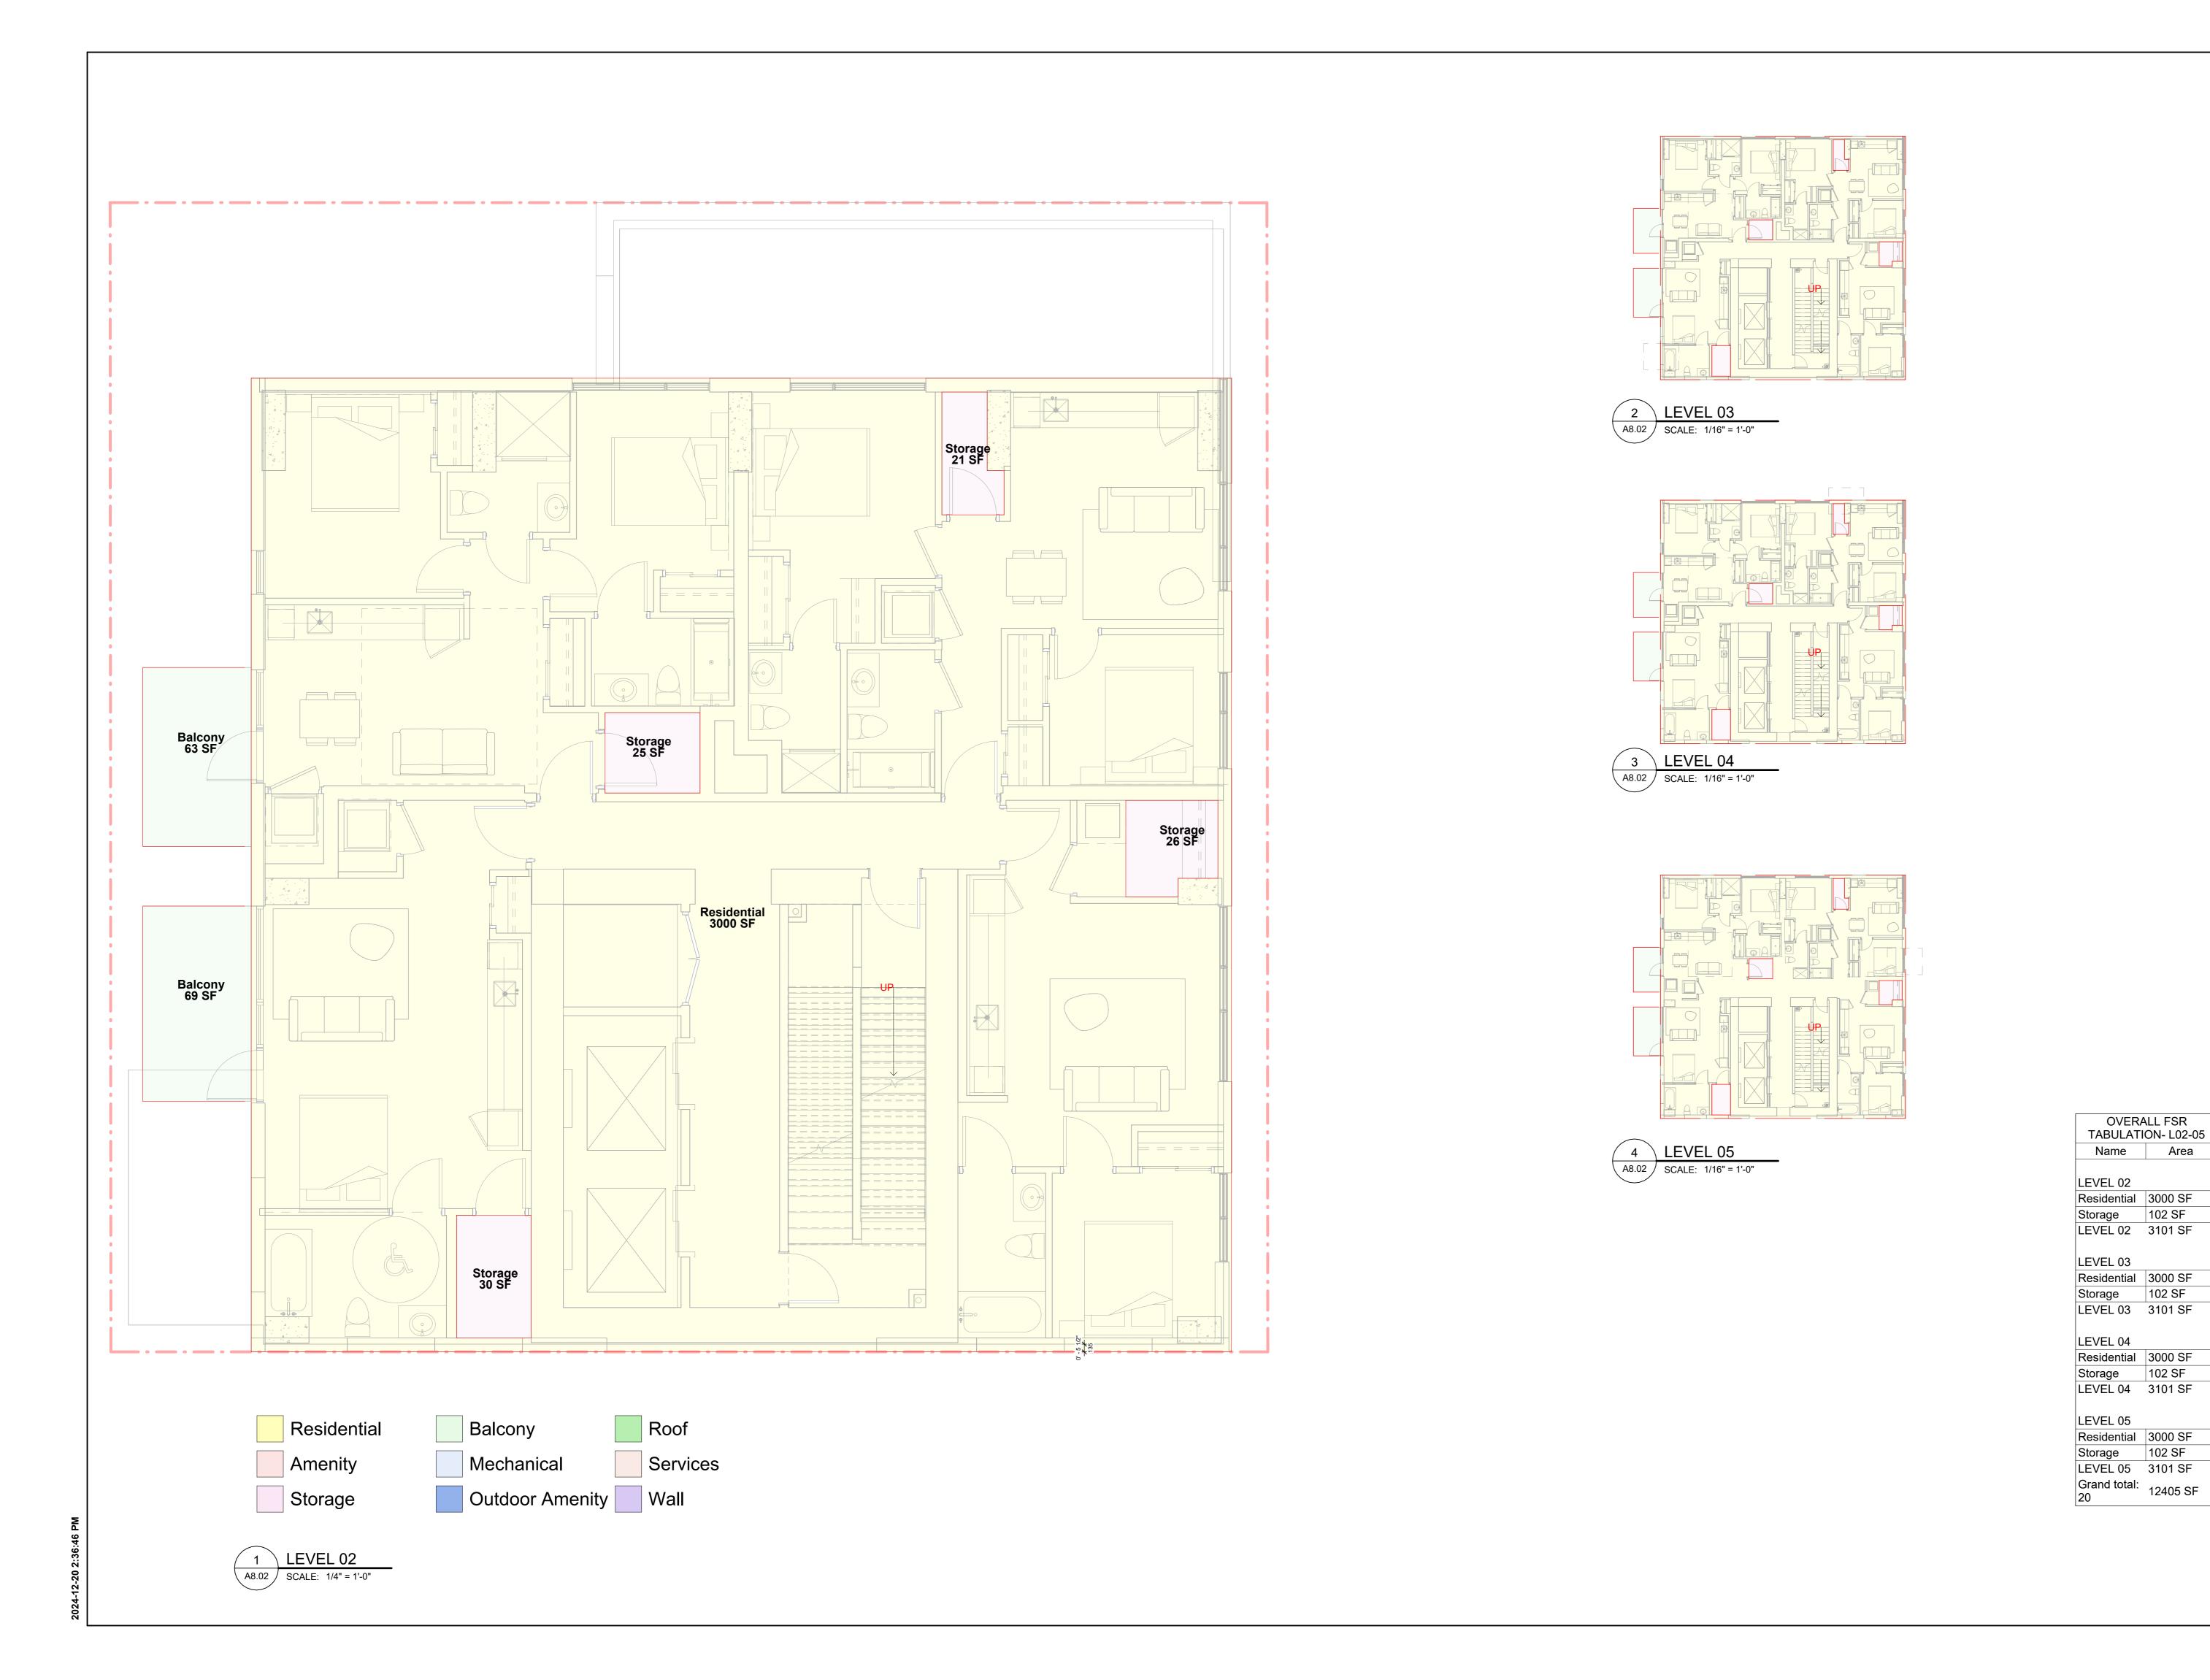
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FSR LEVEL 01

SHEET NUMBER
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FSR LEVEL 02 To 05

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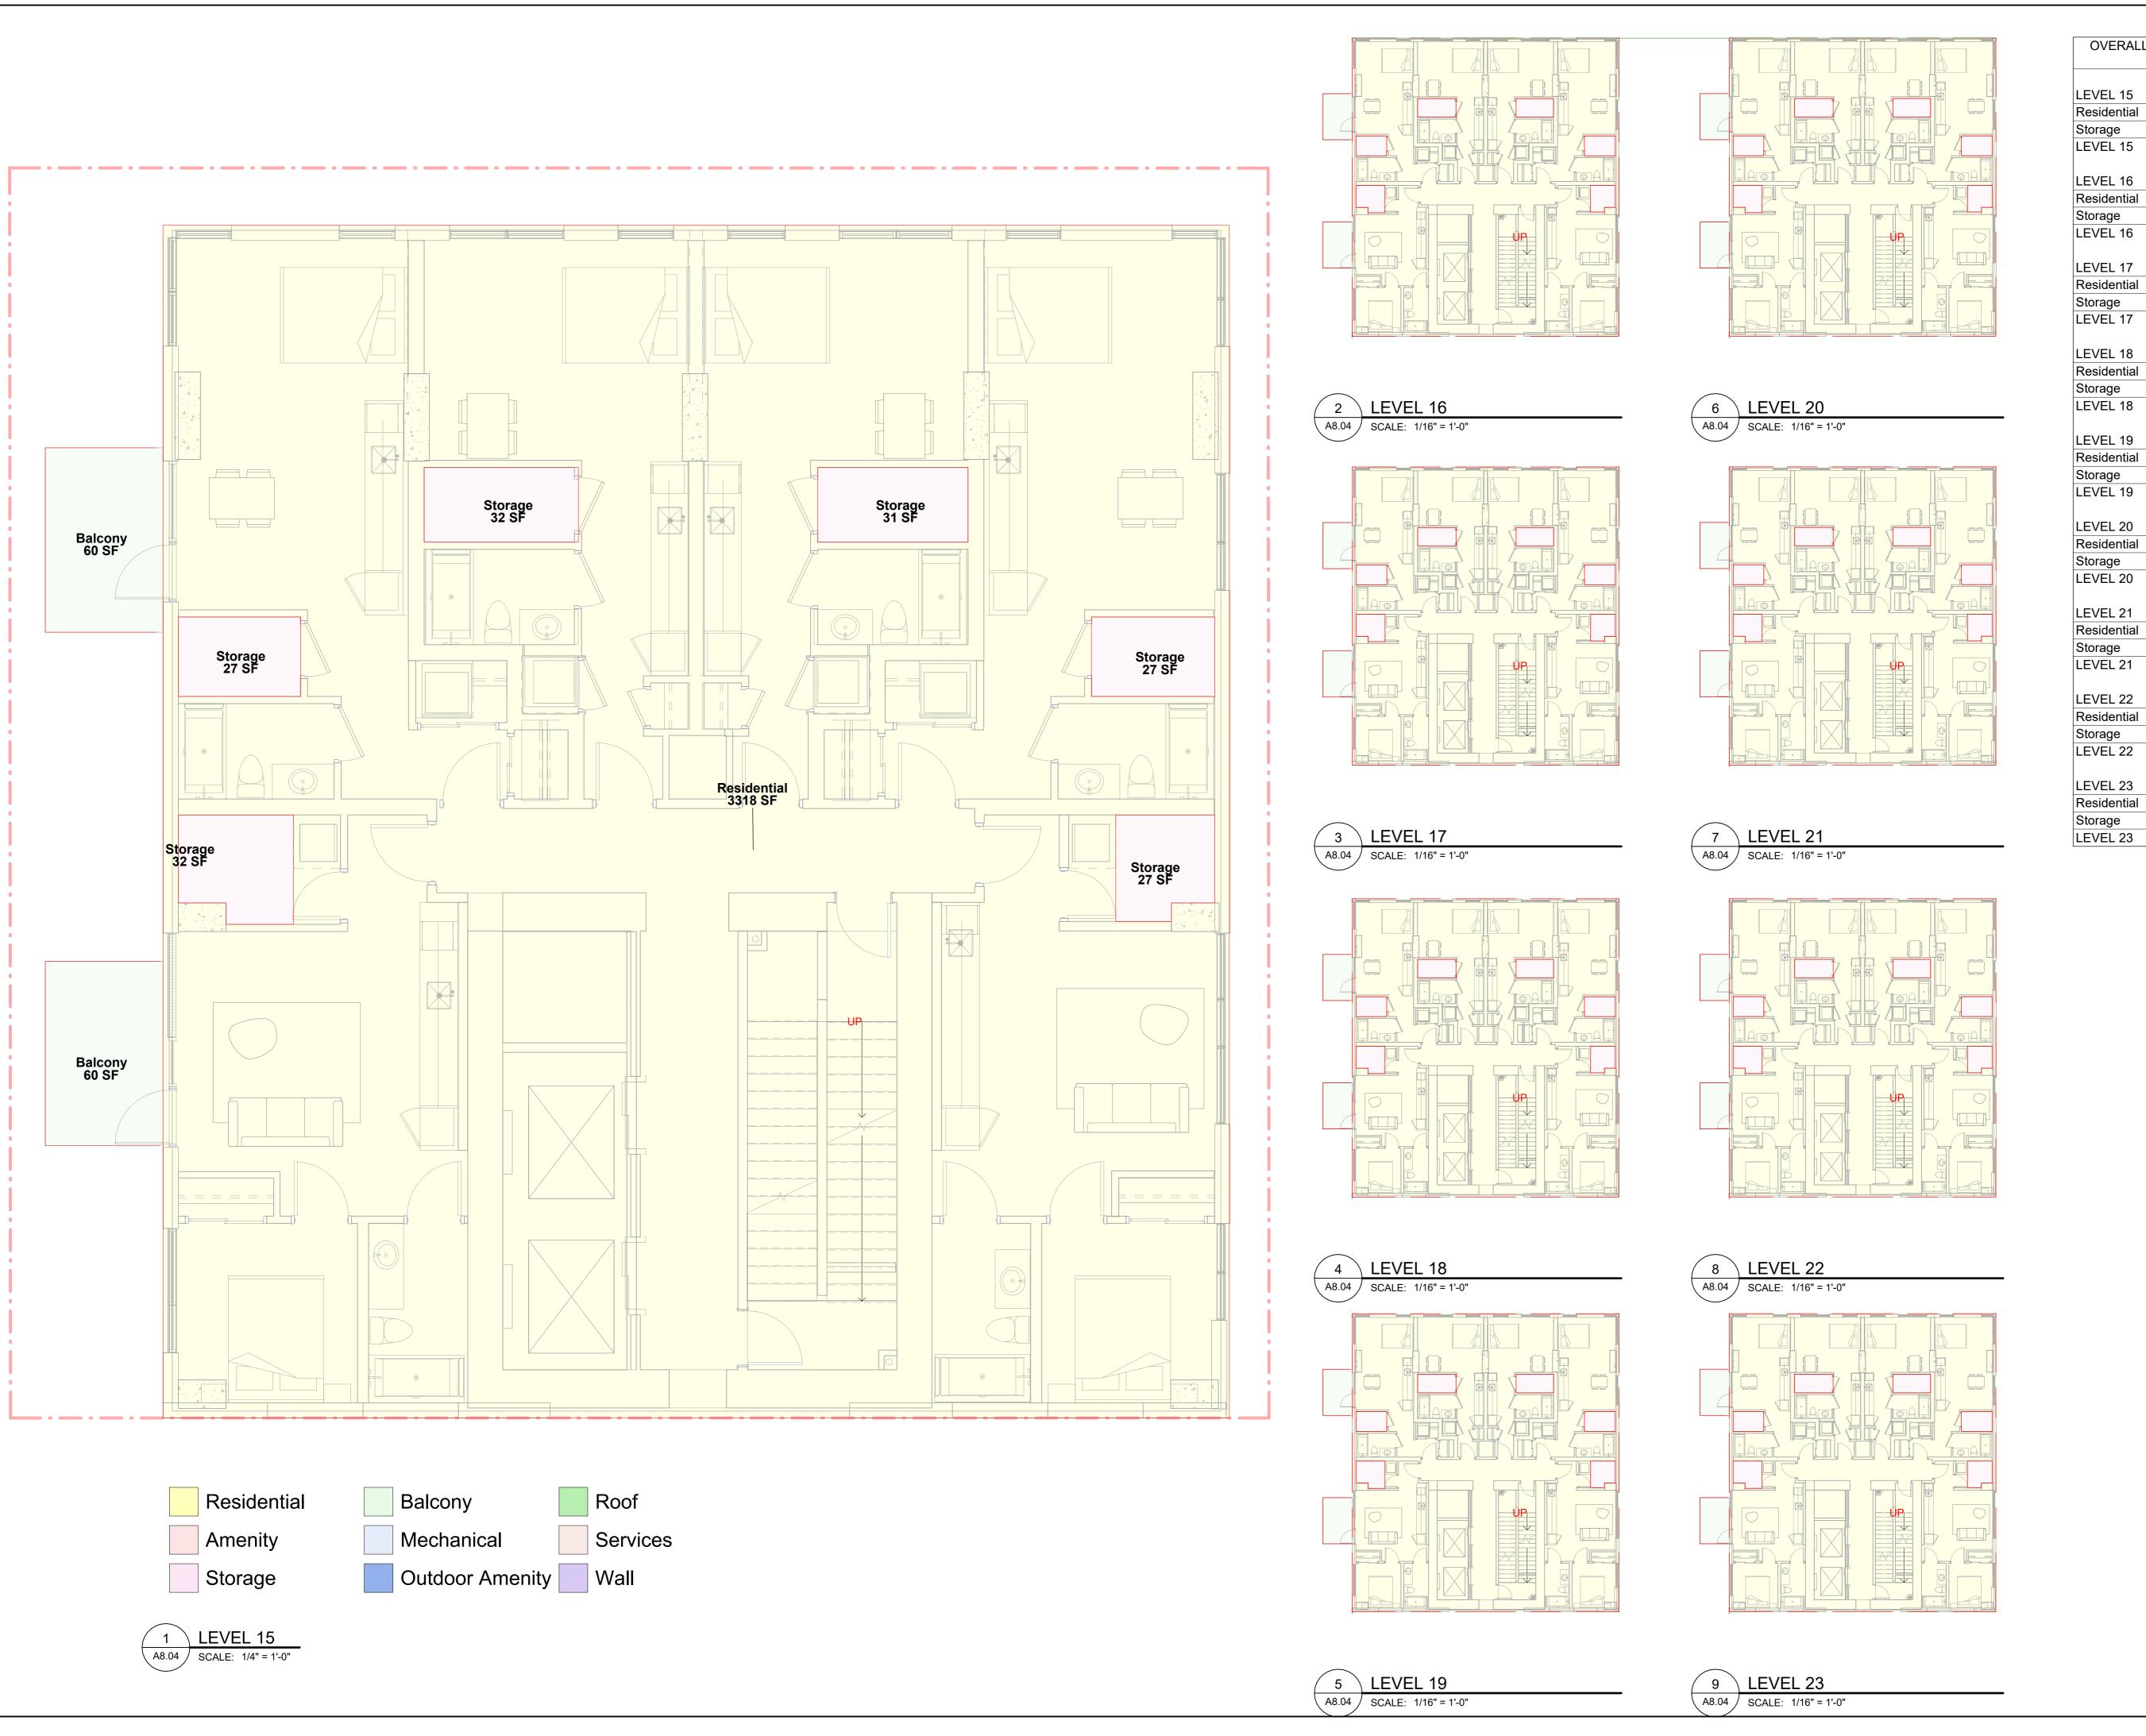
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OVERALL FSR TABULATION-L06-25 LEVEL 15 Residential Storage LEVEL 15 LEVEL 16 Residential Storage LEVEL 16 LEVEL 17 Residential Storage

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3318 SF

175 SF

3493 SF

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175 SF					
3493 SF					
3318 SF					
175 SF					
3493 SF		1	2024-12-20	Issued for rezoning	
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PROJECT MGR: SHEET TITLE

FSR LEVEL 15 To 21


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A8.04





2 LEVEL 25
A8.05 SCALE: 1/16" = 1'-0"

OVERALL FSR 1 L06-	
200-	20
LEVEL 24	
Residential	3318 SF
Storage	175 SF
LEVEL 24	3493 SF
LEVEL 25	

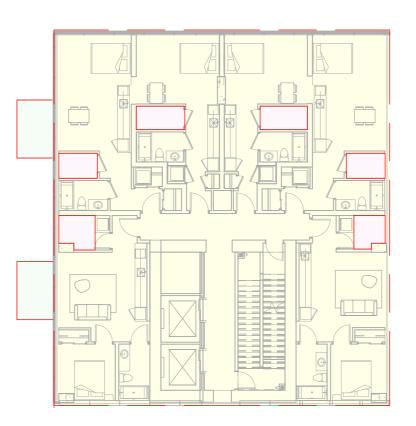3318 SF

175 SF

3493 SF

Residential

Storage

LEVEL 25

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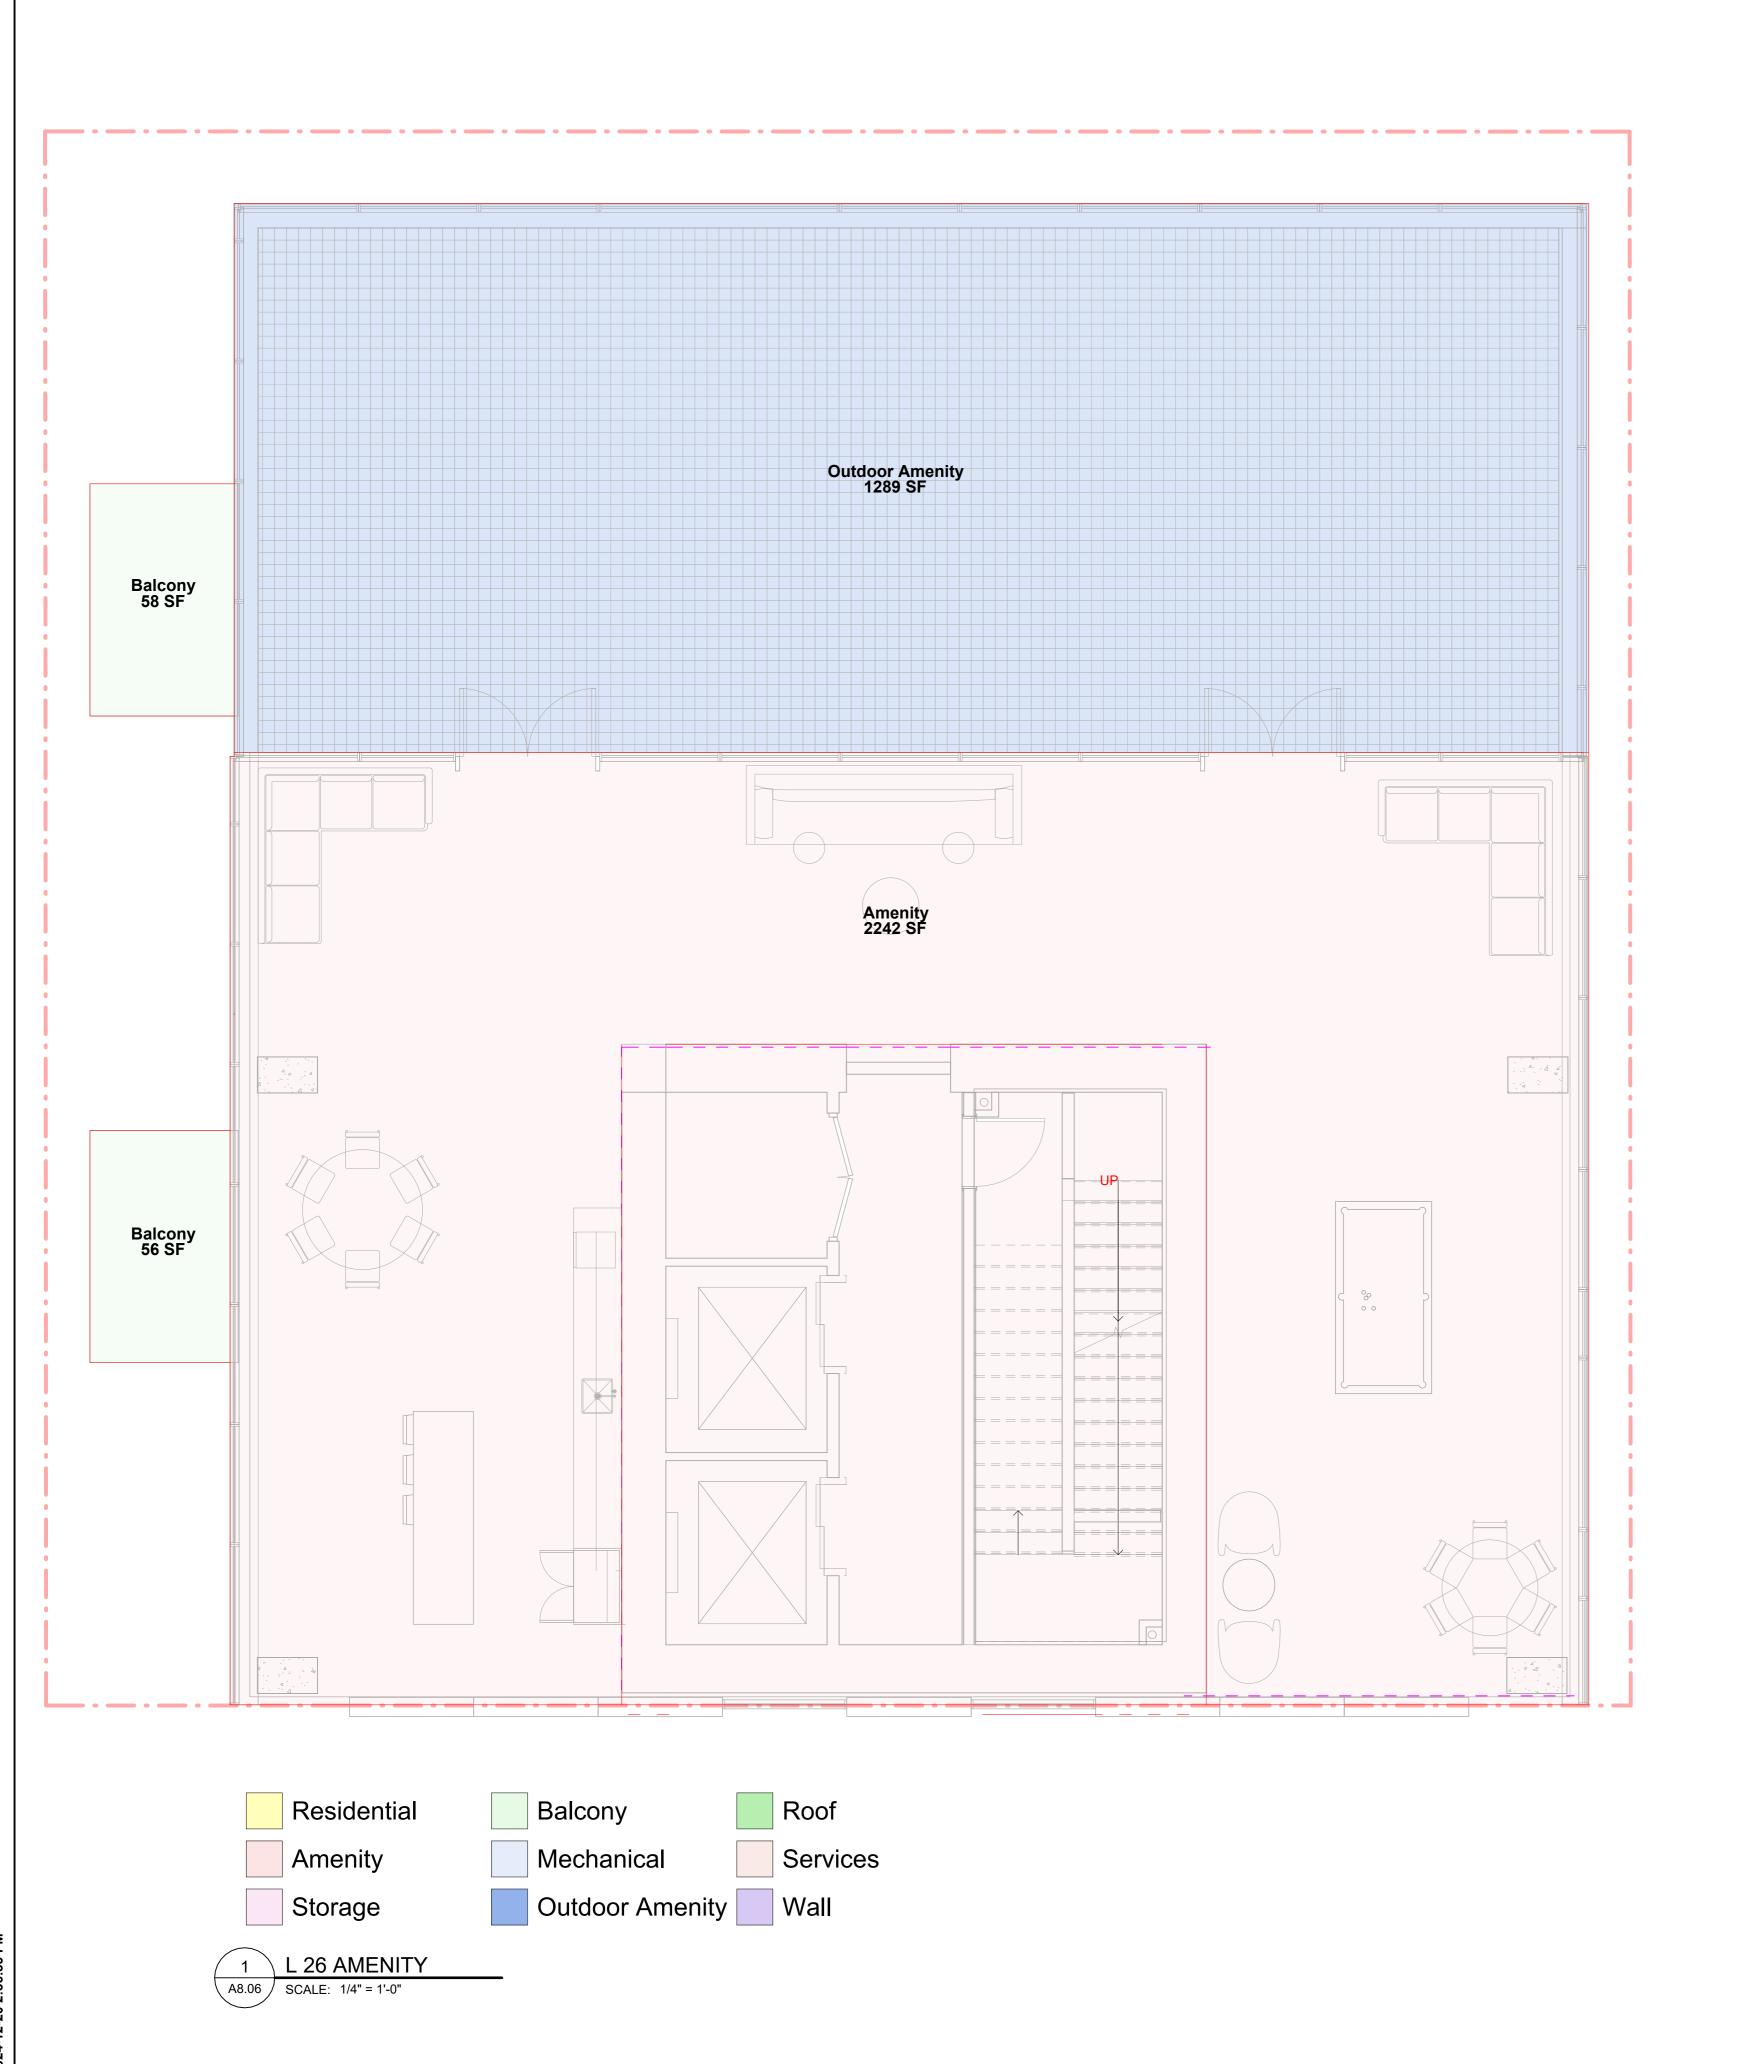
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SHEET TITLE

FSR LEVEL 24 To 25

SHEET NUMBER A8.05

124-12-20 2-36-55 D



OVERALL FSR TABULATION-ROOF

L 26 AMENITY

Amenity 2242 SF L 26 AMENITY 2242 SF The Bloom Group
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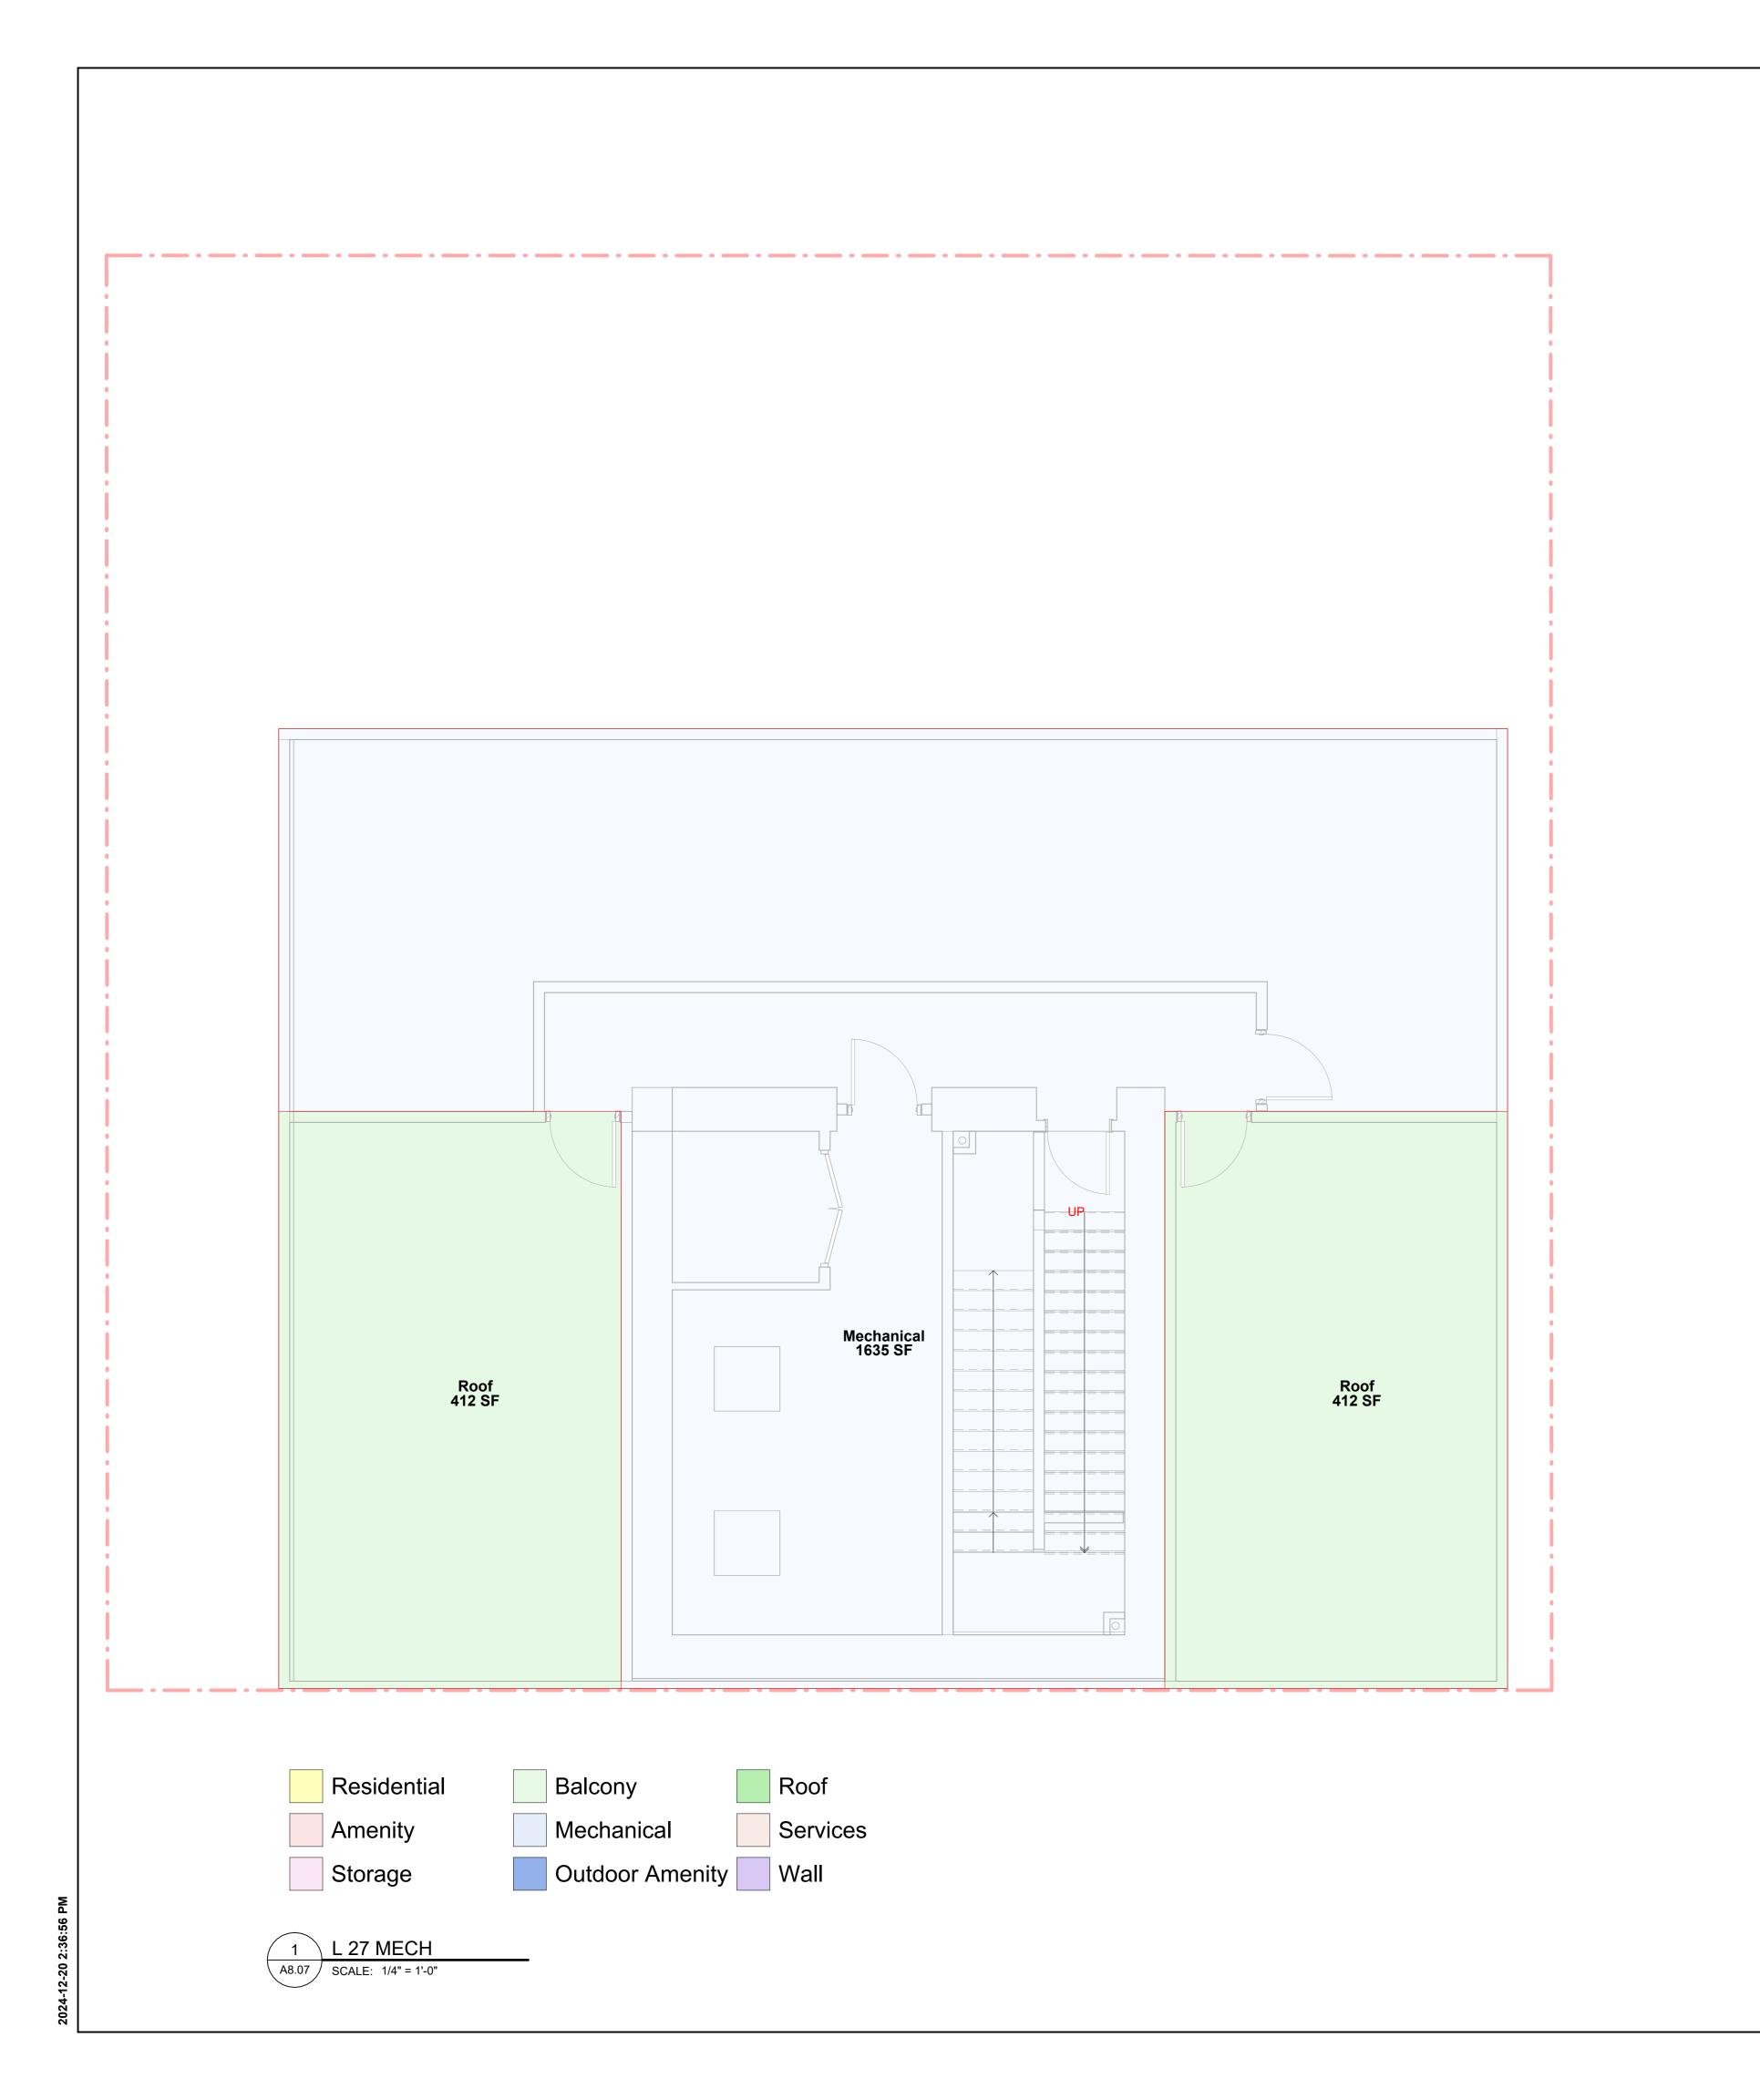
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SHEET TITLE
FSR ROOF LEVEL AMENITY

SHEET NUMBER A8.06

124-12-20 2-36-55 D



OVERALL FSR TABULATION-UPPER MECH. FLOOR CONCEPT

L 27 MECH Mechanical 1635 SF 825 SF L 27 MECH 2459 SF The Bloom Group Nicholson Housing Society

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PRIME CONSULTANT



1285 West Pender Street - Suite 100 Vancouver BC V6E 4B1 Canada tel 604 683 8797 www.arcadis.com

PROJECT

1111 Broughton St

1111 Broughton Street Vancouver,BC

PROJECT NO: 148581 DRAWN BY: CHECKED BY: Author Checker APPROVED BY: PROJECT MGR:

SHEET TITLE FSR UPPER MECH. FLOOR CONCEPT

ISSUE

SHEET NUMBER

A8.07

APPENDIX B

LANDSCAPE DRAWINGS REDUCED 11X17







1111 Broughton St.

LANDSCAPE CONCEPT - SUBMITTED FOR REZONING 2024.12.20



DRAWING LIST

LSK 1.01 PRECEDENT IMAGES 1
LSK 1.02 PRECEDENT IMAGES 2

LANDSCAPE PLANS

L1.01 LEVEL 01 (GROUND FLOOR)

L1.02 LEVEL ROOF

bearmark

design & landscape ltd.

Rezoning Application - 1111 Broughton Street, Vancouver

Landscape Design Rationale:

The project site at 1111 Broughton Street is located at the southwest corner of the intersection of Jepson-Young Lane and Broughton Street. The development application proposes a 26-storey residential high-rise providing a mix of unit types (studios, 1 Bdrm, 2 Bdrm). The lobby doors open directly onto Broughton street and are defined by special paving at the entry and potted plants and paving bands to frame the entry doors.

Facing the corner is a community amenity space with a small patio on the Broughton street side and direct entry access off Broughton. A green landscape garden wraps the corner, providing a buffer between vehicle traffic and residential activity. Another landscape buffer is provided at the north edge of the site between the existing lot and the new development.

The project site is currently empty and has been for some time and thus the existing condition is a vegetated cover of colonizer species. As such, we are proposing to plant as much of the available offsite area as possible, to retain and replace the existing green space character. Planting the back of sidewalk setback area is a key element of our placemaking strategy, adding boulevard planting to the public realm and reflecting to the existing character of the West End neighbourhood. Given the corner lot location, the planted buffers and will help mitigate risks posed by vehicles traffic and improve pedestrian safety.

The roof of the proposed development is dedicated to common amenity area for residents with a generous outdoor patio overlooking Jepson Young lane with views to the north east. The outdoor space is designed to facilitate social interaction between residents and includes overhead shade trees, lounge-style furniture, outdoor entertainment space with dining table and feature lighting.


Lvl

main floor







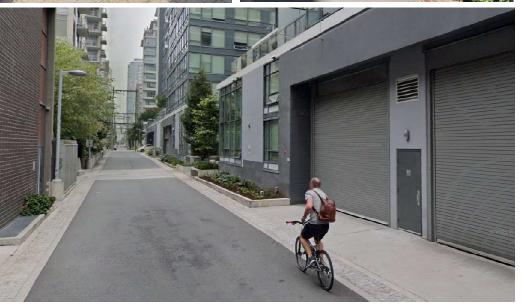

create a friendly a neighbourhood streetscape and laneway by defining character using paving patterns and incorporating in ground planting where possible







General Notes

General Landscape:

All dimensions and elevations must be verified on site prior to commencing construction. Contact designer for any discrepencies between drawing and site conditions.

All work to be completed to CLS/ BCLNA standards.

All hard-landscape to have minimum 2% slope unless otherwise identified.

All soft-landscape surfaces to be sloped a minimum of 2% away from buildings unless otherwise identified.

General Planting:

All specified plant material to meet Landscape Canada specifications and the BCLNA standards.

Minimum Growing Medium Depths:
- Sodded Lawn: 6"
- Shrub Areas: 12"
- Trees: Min. 8" surround of rootball

All sodded lawn to be sand-based unnetted

All new trees to be staked as required for maximum stability.

Issue:

01 Dec. 20, 2024 rezoning



1111 Broughton Vancouver, B.C.

Scale: NTS Date: December, 2024 Drawn By: AP/ JW Project No.: 24041

Drawing Title:

Precedent Images 1

Drawing No.:

LSK 1.01

Arch D

Lvl Roof shared space













General Notes

General Landscape:

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01 Dec. 20, 2024 rezoning



1111 Broughton Vancouver, B.C.

Scale: NTS Date: December, 2024 Drawn By: AP/ JW

Project No.: 24041

Drawing Title:

Precedent Images 2

LSK 1.02

Outdoor rooftop amenity space designed to offer a place for relaxation and opportunities to gather and

